### **DEPARTMENT OF COMMUNITY DEVELOPMENT**BUILDING, PLANNING & ON-SITE SANITATION SECTIONS



Land of Cheese, Trees and Ocean Breeze

1510 - B Third Street Tillamook, Oregon 97141 www.tillamook.or.us

Building (503) 842-3407 Planning (503) 842-3408 On-Site Sanitation (503) 842-3409 Fax (503) 842-1819 Toll Free 1 (800) 488-8280

#### VARIANCE REQUEST #851-21-000244-PLNG: SAXTON

NOTICE TO MORTGAGEE, LIENHOLDER, VENDOR OR SELLER: ORS 215 REQUIRES THAT IF YOU RECEIVE THIS NOTICE, IT MUST BE PROMPTLY FORWARDED TO THE PURCHASER

### NOTICE OF ADMINISTRATIVE REVIEW Date of Notice: November 24, 2021

Notice is hereby given that the Tillamook County Department of Community Development is considering the following:

#851-21-000244-PLNG: A Variance request to reduce the 70% side-width maximum for construction of a single-family dwelling on a property located in the Unincorporated Community of Neskowin. The subject property is accessed via Kinnikinnick Dr., a private road, is zoned Neskowin Low Density Residential (Nesk R-1) and is designated as Tax Lot 3500 of Section 24BD, Township 5 South, Range 11 West, W.M., Tillamook County, Oregon. The applicants and property owners are Lynne & Hume Saxton.

Written comments received by the Department of Community Development prior to 4:00 p.m. on December 7, 2021, will be considered in rendering a decision. Comments should address the criteria upon which the Department must base its decision. A decision will be rendered no sooner than the next business day, December 8, 2021. Notice of the application, a map of the subject area, and the applicable criteria are being mailed to all property owners within 250 feet of the exterior boundaries of the subject parcel for which an application has been made and other appropriate agencies at least 14 days prior to this Department rendering a decision on the request.

A copy of the application, along with a map of the request area and the applicable criteria for review are available for inspection at the Department of Community Development office located at 1510-B Third Street, Tillamook, Oregon 97141. They are also available on the Tillamook County Department of Community Development website: <a href="http://www.co.tillamook.or.us/gov/ComDev/landuseapps">http://www.co.tillamook.or.us/gov/ComDev/landuseapps</a>

If you have any questions about this application, please contact the Department of Community Development at (503) 842-3408 ext. 3317 or claws@co.tillamook.or.us.

Sincerely.

Christopher S. Laws, Planner II

Sarah Absher, CFM, Director

Enc. Maps and applicable ordinance criteria

#### REVIEW CRITERIA

#### ARTICLE VIII - VARIANCE PROCEDURES AND CRITERIA

**SECTION 8.030: REVIEW CRITERIA:** A VARIANCE shall be granted, according to the procedures set forth in Section 8.020, if the applicant adequately demonstrates that the proposed VARIANCE satisfies all of the following criteria:

- (1) Circumstances attributable either to the dimensional, topographic, or hazardous characteristics of a legally existing lot, or to the placement of structures thereupon, would effectively preclude the enjoyment of a substantial property right enjoyed by the majority of landowners in the vicinity, if all applicable standards were to be met. Such circumstances may not be self-created.
- (2) A VARIANCE is necessary to accommodate a use or accessory use on the parcel which can be reasonably expected to occur within the zone or vicinity.
- (3) The proposed VARIANCE will comply with the purposes of relevant development standards as enumerated in Section 4.005 and will preserve the right of adjoining property owners to use and enjoy their land for legal purposes.
- (4) There are no reasonable alternatives requiring either a lesser or no VARIANCE.


#### SECTION 4.005: RESIDENTIAL AND COMMERCIAL ZONE STANDARDS

In all RESIDENTIAL AND COMMERCIAL ZONES, the purpose of land use standards is the following:


- (1) To ensure the availability of private open space;
- (2) To ensure that adequate light and air are available to residential and commercial structures;
- (3) To adequately separate structures for emergency access;
- (4) To enhance privacy for occupants of residences;
- (5) To ensure that all private land uses that can be reasonably expected to occur on private land can be entirely accommodated on private land, including but not limited to dwellings, shops, garages, driveways, parking, areas for maneuvering vehicles for safe access to common roads, alternative energy facilities, and private open spaces;
- (6) To ensure that driver visibility on adjacent roads will not be obstructed;
- (7) To ensure safe access to and from common roads;
- (8) To ensure that pleasing views are neither unreasonably obstructed nor obtained;
- (9) To separate potentially incompatible land uses;
- (10) To ensure access to solar radiation for the purpose of alternative energy production.

# EXHBIT A




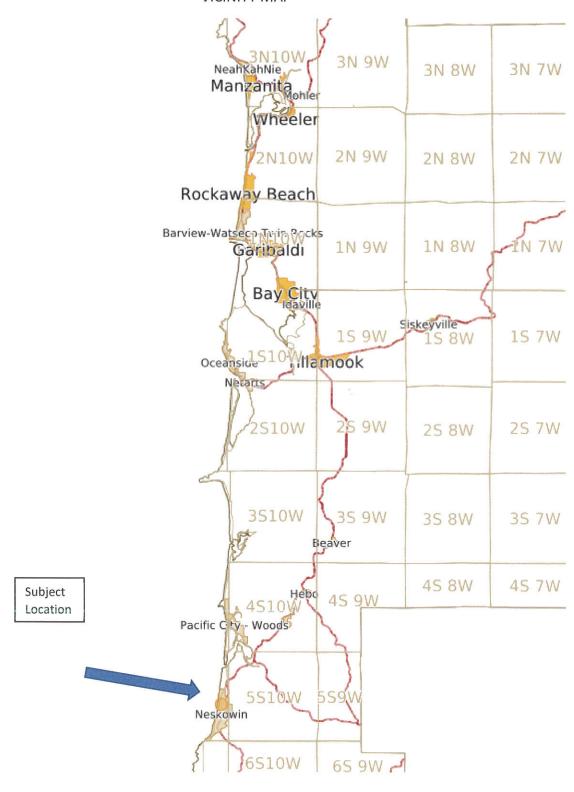

851-21-000244-PLNG SAXTON

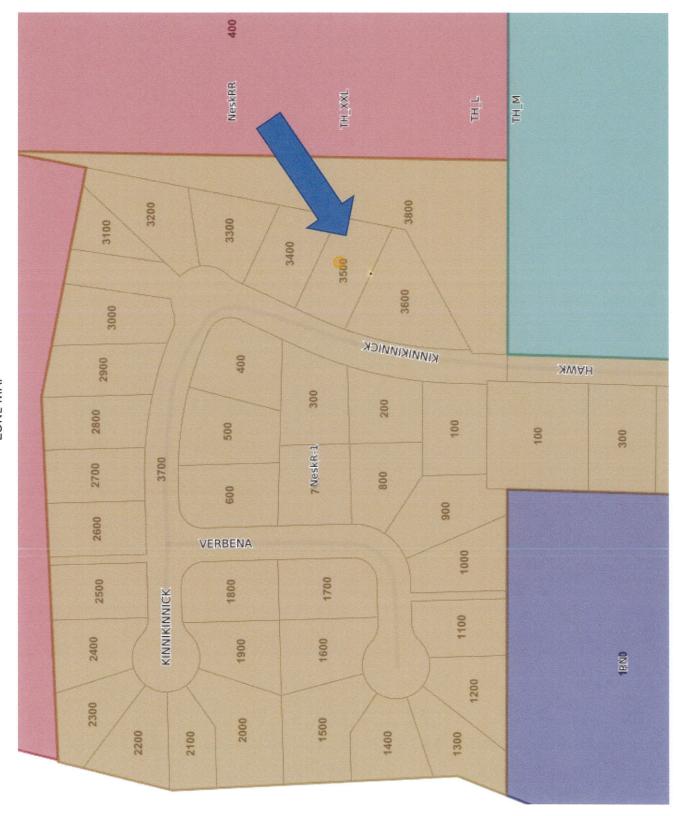

851-21-000244-PLNG SAXTON

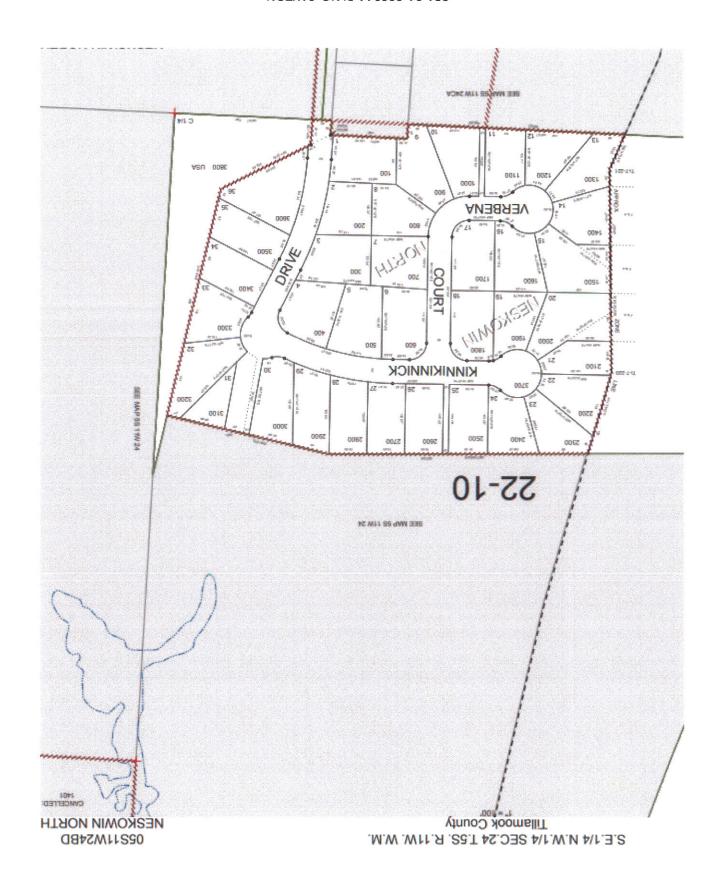

# EXHIBIT B



# Tillamook County Department Community Development 1510-B Third Street. Tillamook, OR 97141 Www.co.tillamook.or.us JUL 0 1 2021

Date Stamp

**OFFICE USE ONLY** 

### PLANNING APPLICATION

| <b>Applicant</b> ⊠ (Check Box if Same as Pro  | perty Owner)   |   |           |
|---|--|---|-----------|
| Name: Phone:  |  |   |           |
| Address:  |  |   |           |
| City: State:  | Zip:   |   |           |
| Email:  |  |   | nied      |
|   |  | Received by:  |           |
| Property Owner  |  | Receipt #:  |           |
| Name: Lynne Saxton Phone:   |  | Permit No:  |           |
| Address: 45955 Kinnikinick Drive  | <u> </u>   | 0   | PLNG      |
| City: Neskowin State: 0   | DR Zip: 97149  | 851-4-00 11-1   | LIVO      |
| Email: lynne.saxton@gmail.com   |  |   |           |
| Request: A variance to the maximum 70% of Carport with a new garage/bedroom. The 56'-4 ½". It does not exceed the existing 6 Proposed new structure and house width | new construction exceeds the n<br>55'-4 3/8" width of the current he | naximum allowable width                                       | ı of      |
|   |  |   |           |
| Type II   | Type III   | Type IV   |           |
| ☐ Farm/Forest Review  | - Extension of Time  | Ordinance Amendment   |           |
| <ul> <li>☐ Conditional Use Review</li> <li>☐ Detailed Hazard Report</li> <li>☐ Conditional Use (As deemed)</li> </ul>   |  | <ul> <li>Large-Scale Zoning Map</li> <li>Amendment</li> </ul> |           |
| <ul><li>☑ Variance</li><li>☑ Conditional Use (As deemed by Director)</li></ul>  |  | ☐ Plan and/or Code Text                                       |           |
| ☐ Nonconforming Review (Major or Minor) ☐ Ordinance Amendment   |  | Amendment   |           |
| Development Permit Review for Estuary   | ☐ Map Amendment  |   |           |
| Development   | ☐ Goal Exception   |   |           |
| ☐ Non-farm dwelling in Farm Zone  |  |   |           |
| ☐ Foredune Grading Permit Review  |  |   |           |
| $\square$ Neskowin Coastal Hazards Area   |  |   |           |
| ocation:  | s  |   |           |
| Site Address: 45955 Kinnikinick Drive Nesk  | owin Oregon 97149  |   |           |
| Map Number: 5-11-24-BD-3500 Lot 35 c  | f Neskowin North   |   |           |
| Township Rang   | 2  | Section Tax Lot(s)  |           |
| Clerk's Instrument #:   |  |   |           |
| Authorization   |  |   |           |
| This permit application does not assure permit  | approval. The applicant and/or pro                                   | perty owner shall be respon                                   | sible for |
| obtaining any other necessary federal, state, ar  |  |   |           |
| complete, accurate, and consistent with other i   | nformation submitted with this app                                   | lication.   |           |
| ynne H. Saxton  |  | Jun 29, 20  | )21       |
| me H. Saxton (Jun 29, 2021 12.45 PDT) Property Owner Signature (Required)   |  | Date  |           |
| Lynne H. Saxton<br>One H. Saxton (Jun 23, 2021 12.45 PDT)   |  | Jun 29, 20  | 021       |
| Applicant Signature   |  | Date  |           |
|   |  |   |           |
| Landlin Anglinki  | 20/24  |   |           |
| Land Use Application Rev. 6/  | 29/21  | P:  | agę       |

#### **SECTION 8.030: REVIEW CRITERIA**

(1) Circumstances attributable either to the dimensional, topographic, or hazardous characteristics of a legally existing lot, or to the placement of structures thereupon, would effectively preclude the enjoyment of a substantial property right enjoyed by the majority of landowners in the vicinity, if all applicable standards were to be met. Such circumstances may not be self-created.

The existing dimensional parameters of the site along with the location of the existing dwelling and driveway location would lend itself to a garage to be located in the location of the current carport. In order to meet the 70 % width rule the new garage structure would need to be located in front of the home. Given the setback requirement, this would not be possible.

(2) A VARIANCE is necessary to accommodate a use or accessory use on the parcel which can be reasonably expected to occur within the zone or vicinity.

The variance is required to accommodate the construction of the garage and bedroom. The garage and additional bedroom are uses that are reasonably to be expected to occur within this residential zone and consistent with neighboring homes. In reviewing neighboring homes along Kinnikinick within the same Neskowin R-1 zone, it is obvious that most of the homes, particularly the homes at the North end of the development (45805, 45825,45835,45845, 45775, 45735,45915, 45855) are constructed to the full width of the lot up to the 5 foot side yard setbacks and do not meet the 70% rule. See the attached LUR-1 drawing attached. We would reasonably expect the same consideration.

(3) The proposed VARIANCE will comply with the purposes of relevant development standards as enumerated in Section 4.005 and will preserve the right of adjoining property owners to use and enjoy their land for legal purposes.

The proposed design preserves the intent of the supplementary regulations set forth in Section 4.005

(1) By locating the new garage in essentially the same location as the current carport, the private open space in the front and rear of the home is maintained.

- (2) The new garage meets the current side, front and rear setbacks, which are the reason setbacks were developed, specifically to maintain adequate light and air to the structures. The new garage is also separated from the main home by 5 9" to allow the existing homes' windows and ventilation to be maintained.
- (3) Adequate access for emergency has been maintained to all sides of the home from the public right of way and off-street parking is maintained for emergency vehicles as well.
- (4) The prosed design focusses the occupants' views and access towards east and west and maintains privacy for the immediate neighbors to the South
- (5) No changes are being implemented that would alter the houses and garage relationship to the common roads. All the private uses noted are continuing to be occurring on the owner's private land.
- (6) & (7) No changes have been implemented that would alter driver visibility or safe access to and from the common road which is a private drive.
- (8) By locating the new structure in essentially the same location as the current carport no views are unreasonably obstructed nor obtained. There is an esisting mature vegetation and treed buffer between the proposed structure and the neighbors to the south that is being maintained.
- (9) The proposed uses are in line with the approved Zoning uses for the property and no incompatible uses are being proposed.
- (10) The new structure, due to its location, orientation and the natural sun route would not cause any solar shading to the neighbor's property and would not inhibit the applications property from having full solar access.
- (4) There are no reasonable alternatives requiring either a lesser or no VARIANCE.

We looked at alternate designs in an effort to fit withing the allowable 70% width. None of the options could accommodate the owners programming needs. The minimal width available to fit within those guidelines compromised the plans to the point of making the project unbuildable.



July 29, 2021

Sarah Absher, Director Tillamook County Department of Community Development 1510-B Third Street. Tillamook, OR 97141

Re: Variance for 70% maximum building width along the front yard for property located at 45955 Kinnikinick Drive, Neskowin OR.

Dear Director Absher,

Please find enclosed, along with this letter, a completed Planning Application package for a variance request for the carport replacement to the Lynne and Ron Saxton's property located at 45955 Kinnikinick Drive, Neskowin OR.

It is our understanding that you will be reviewing the variance. I would appreciate it if you would verify that we do, in fact, need to submit for this variance since we were initially told that if the new garage did not exceed the width of the current home/carport we could submit for the building permit without needing a variance.

Once we submitted our plans for a building permit, we were then notified that we did need the variance. In any event, we have supplied the Variance Application and support drawings and documents for your use and review. Certainly, if there is a way to avoid the variance, we could save your staff significant time and effort and save our client the estimated 12-week review time so that we could submit for the building permit and get the work constructed during this current building season.

Pleas find enclosed:

Planning Application

Planning Application narrative with Drawing LUR - 1

Architectural Drawings;

A.0 Cover Sheet

A.1 Title sheet

A.2 Site Survey

A.3 Site Plan

A.3.1 Existing Site Plan and Existing photos

A.4 Floor Plans

A.5 Roof Plan

A.6 Building Elevations

A.7 Building Elevations

A.8 Building Sections

Thank you for your assistance.

Regards,

Dave Giulietti, Principal

(enclosures)



COPY TO\_

### GIULIETTI / SCHOUTEN AIA, Architects, P.C.

2800 N.W. Thurman Street Portland, Oregon 97210

JUNE 29,2021 Telephone (503) 223-0325 Fax (503) 241-9323 TILLAMOOK COUNTY COMM. DVLP. VARIANCE - TYPE II REVIEW DOCUMENTS 1510-B THIRD STREET TILLAMOOK, OR 97141 WE ARE SENDING YOU ☐ Attached ☐ Under separate cover via \_\_\_ \_the following items: X Prints ▼ Plans ☐ Shop drawings ☐ Samples □ Specifications X APPLICATION + NARRATIVE CRITERIA + COVERLETTER ☐ Change order □ Copy of letter COPIES DATE NO. DESCRIPTION 6/29/2 BUILDING APPLICATION (8.5×11) DRAWINGS: PLANS, ELEVATIONS, SECTIONS (FOLDED 24 x 36) 2 NARRATIVE RESPONSE TO REVIEW CRITERIA (8.5×11) THESE ARE TRANSMITTED as checked below: □ For approval ☐ Approved as submitted ☐ Resubmit \_\_\_\_\_ copies for approval ☐ For your use □ Approved as noted ☐ Submit \_\_\_\_\_ copies for distribution ☐ Returned for corrections ☐ Return \_\_\_\_\_ corrected prints ☐ As requested X FOR VARIANCE APPLICATION SUBMISSION ☐ For review and comment ☐ FOR BIDS DUE \_ ☐ PRINTS RETURNED AFTER LOAN TO US REMARKS\_

SIGNED: DWA

LETTER OF TRANSMITTAL


ANDREW STRICKER



SAXTON RESIDENCE CARPORT REPLACEMENT - GARAGE

GIULIETTI SCHOUTEN
AIA ARCHITECTS

### ARCHITECTURAL SYMBOLS

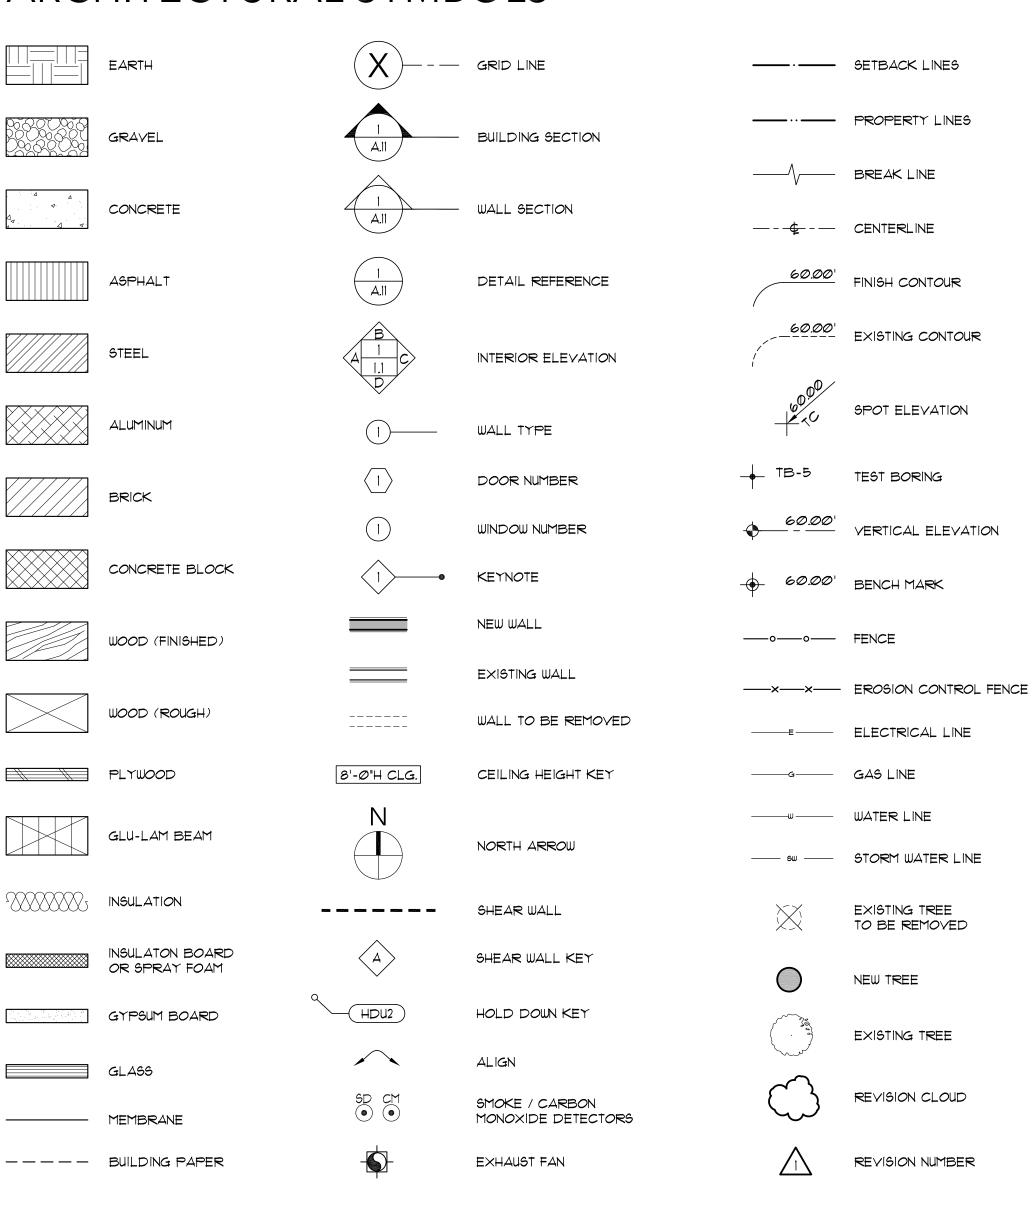

### CONSTRUCTION NOTES

### **GENERAL NOTES**

- 1. ALL WORK TO MEET APPLICABLE LOCAL AND
- STATE BUILDING CODES. 2. ALL NEW PLUMBING FIXTURES TO CONFORM TO LATEST PLUMBING CODE.
- 3. ALL HANDRAILS AND GUARDS SHALL MEET REQUIREMENTS OF SEC. R311 AND SEC. R312 OF THE
- 4. ALL REFERENCES TO METAL FRAMING CONNECTORS AND ACCESSORIES REFER TO "SIMPSON" PRODUCTS. INSTALL PER MANUFACTURER'S RECOMMENDATIONS.
- 5. PROVIDE 110 V INTERCONNECTED SMOKE DETECTORS WITH BATTERY BACKUP AT ALL FLOOR LEVELS AS PER ORSC, SEC. 314. SMOKE DETECTORS SHALL BE INSTALLED IN EACH SLEEPING ROOM, OUTSIDE OF EACH SEPARATE SLEEPING AREA IN THE IMMEDIATE VICINITY OF THE BEDROOMS.

### FRAMING PLAN NOTES

- 1. SHEAR WALLS ARE INDICATED BY DASHED LINE
- (----) ALONG LENGTH OF WALL. 2. ALL REFERENCES TO METAL FRAMING CONNECTORS AND ACCESSORIES REFER TO

"SIMPSON" PRODUCTS. INSTALL PER

- MANUFACTURER'S INSTALLATION RECOMMENDATIONS. 3. PROVIDE FASTENERS AS PER FASTENER SCHEDULE, ORSC TABLE 602.3(1) UNLESS SPECIFIED DIFFERENTLY ON DRAWINGS AND SHEAR
- WALL SCHEDULE, STAPLES NOT PERMITTED IN O.S.B. SHEATHING. 4. DRILLING AND NOTCHING OF STRUCTURAL MEMBERS TO BE IN ACCORDANCE WITH ORSC
- R502.8, R602.6, AND R602.6.1. 5. CONTRACTOR IS REQUIRED TO SUBMIT MANUFACTURERS ROOF TRUSS DETAILS, IF APPLICABLE, TO BUILDING DEPARTMENT FOR APPROVAL PRIOR TO ROOF CONSTRUCTION. SUBMIT 3 SETS TO ARCHITECT FOR REVIEW PRIOR
- TO FABRICATION. 6. COLUMNS AND POSTS SHALL BE ADEQUATELY ANCHORED TO PREVENT LATERAL DISPLACEMENT,
- ORSC R407.3. 1. EXTERIOR DECKS SHALL BE CONSTRUCTED WITH NATURALLY DURABLE OR PRESSURE-TREATED
- WOOD, ORSC 317.1.4. 8. EACH END OF EACH HEADER TO BE SUPPORTED WITH (1) KING STUD AND (1) TRIM STUD NAIL
- LAMINATED UNLESS NOTED OTHERWISE. 9. EACH POST/COLUMN TO BE CONTINUOUS TO FOUNDATION UNLESS SUPPORTED BY BEAM/HEADER.

### FLOOR PLAN NOTES

DRAWINGS/SCHEDULE.

- 1. ALL DIMENSIONS ARE TO FACE OF STUD (F.O.S.) UNLESS
- NOTED OTHERWISE. 2. ALL EXTERIOR WALLS TO USE 2X6 WOOD STUDS 16" O.C. UNLESS NOTED OTHERWISE. ALL INTERIOR WALLS TO BE
- 2×4 WOOD STUDS 16" O.C. UNLESS NOTED OTHERWISE. 3. ALL SLEEPING ROOMS SHALL BE PROVIDED WITH EMERGENCY EGRESS OPENINGS, ORSC SEC. R310. CONTRACTOR IS RESPONSIBLE FOR MAKING SURE THAT ALL SLEEPING ROOMS TO BE PROVIDED W/EGRESS WINDOW WHETHER OR NOT INDICATED ON
- 4. CONTRACTOR IS RESPONSIBLE FOR INSTALLING TEMPERED GLASS IN ALL LOCATIONS AS REQUIRED BY CODE WHETHER OR NOT INDICATED AS TEMPERED ON DRAWINGS/SCHEDULE. SAFETY GLAZING SHALL BE PROVIDED IN ACCORDANCE WITH ORSC R308.4: A. AT TUBS OR SHOWERS WHERE THE GLAZING IS LESS THAN 60" ABOVE THE DRAIN, B. WITHIN 24" OF A DOOR AND LESS THAN 60' ABOVE THE FLOOR, C. PANES GREATER THAN 9 SQ. FT. AND LESS THAN 18" ABOVE THE FLOOR.
- 5. ALL HANDRAILS AND GUARDRAILS SHALL MEET REQUIREMENTS OF ORSC SEC. R311 AND R312. A HANDRAIL 16 REQUIRED AT EVERY STAIR OF 3 OR MORE RISERS. PROVIDED A 1.5"-2-5/8" DIAMETER RAIL WITH 1.5" MIN. BETWEEN HANDRAIL AND WALL AND MOUNTED AT +30"-38" ABOVE THE TREAD NOSING, ORSC R311.7.7.1. HANDRAILS WHICH FUNCTION AS GUARDS SHALL BE 34"-38" ABOVE THE TREAD NOSING, ORSC R311.7.8.3.
- 6. PROVIDE 110 Y INTERCONNECTED SMOKE DETECTORS/CARBON MONOXIDE ALARMS WITH BATTERY BACKUP AT ALL FLOOR LEVELS, ORSC SEC. R314 @ R315. SMOKE DETECTORS/CARBON MONOXIDE ALARMS TO BE INSTALLED IN EACH SLEEPING ROOM, OUTSIDE OF EACH
- SEPARATE SLEEPING AREA IN THE IMMEDIATE VICINITY OF THE BEDROOMS. 1. ALL BATHROOMS TO HAVE EXHAUST FAN TO EXTERIOR (80 CFM FOR BATHING FACILITIES/ 50 CFM FOR TOILET AND
- LAVATORY ONLY) ORSC R303.3 CONTROLLED BY A DE-HUMIDISTAT, TIMER OR SIMILAR AUTO. CONTROL. 8. ALL GYP. BD. WALLS TO HAVE A SMOOTH FINISH (LEVEL 4),
- UNLESS NOTED OTHERWISE. 9. GLAZING SHALL BE INSTALLED AS REQ'D BY ORSC SEC. R308. ALL WINDOWS TO MEET CLASS U=0.30. ALL EXTERIOR DOORS OTHER THAN THE MAIN ENTRY TO MEET CLASS U=0.20. ENTRY DOOR TO HAVE A U=.54 W/ A MAX. AREA OF 24 SQ. FT.
- 10. PROVIDE CARBON MONOXIDE DETECTOR INSIDE OF DOOR TO THE HOUSE FROM THE GARAGE.
- II. 1/2" GYP. BOARD IS REQ'D AT THE SEPARATION WALL BETWEEN GARAGE AND RESIDENCE, ORSC R302.6
- 12. A 1-3/8" MIN. SOLID CORE DOOR OR A 20-MINUTE RATED FIRE DOOR IS REQUIRED AT THE SEPARATION WALL
- BETWEEN GARAGE AND RESIDENCE, ORSC R302.5.1.1 13. MIN. 5/8" TYPE-X GYP. BOARD IS REQ'D ON THE GARAGE CEILING AND ALL SUPPORTING WALLS WHEN LIVING AREAS ARE ABOVE. WRAP ALL BEAMS AND SUPPORTING POSTS, ORSC TABLE R302.6.
- 14. EXTERIOR POSTS SHALL BE APPROVED DECAY-RESISTANT OR PRESSURE-TREATED WOOD, SHALL PROJECT 2" MIN. ABOVE GRADE AND BE SEPARATED THERE BY AN IMPERVIOUS MOISTURE BARRIER, ORSC
- 15. PRE-FAB FIREPLACES OR WOOD STOVES SHALL BE INSTALLED PER MANUFACTURER'S SPECIFICATIONS. ORSC
- 16. CHIMNEYS ON FORESTED LAND SHALL INCLUDE SPARK ARRESTORS. ORSC RIØØ3.9.2.
- 17. COMBUSTION AIR IS REQUIRED FOR ALL GAS OR OIL FIRED APPLIANCES PER ORSC CHPT 17.
- 18. A 2'-0" MIN. DOOR WIDTH IS REQ'D AT WATER HEATERS, ORSC P2811.0.
- 19. A NON-REMOVABLE BACKFLOW PREVENTION DEVICE IS REQUIRED ON ALL EXTERIOR HOSE BIBS. OPSC P2903.5.6.Z
- 20.THE MAXIMUM AMOUNT OF WATER USED BY NEW PLUMBING FIXTURES MAY NOT EXCEED THE FOLLOWING: TOILETS, 1.6 GAL. PER FLUSH± OPSC P2702.0.
- 21. SHOWERS MUST BE A MINIMUM OF 1,024 SQ. IN. AND SHALL BE CAPABLE OF ENCOMPASSING A 30" CIRCLE. OPSC

### **FOUNDATION NOTES**

- 1. ALL WORK TO MEET APPLICABLE LOCAL & STATE BLDG
- 2. CONTRACTOR, ARCHITECT AND CONCRETE SUBCONTRACTOR SHALL HAVE A PRE-CONST. MEETING PRIOR TO THE START OF CONCRETE WORK
- 3. ALL REFERENCES TO METAL FRAMING CONNECTORS \$ ACCESSORIES REFER TO "SIMPSON" PRODUCTS. INSTALL
- PER MFG'S INSTALLATION RECOMMENDATIONS. 4. ALL WOOD IN CONTACT W/ CONCRETE TO BE PRESSURE TREATED MATERIAL (P.T.) OR FND GRADE REDWOOD, ORSC
- 5. CONTRACTOR SHALL COORDINATE CONCRETE WORK W/ ALL OTHER TRADES.
- 6. ASSUME 1500 P.S.F. SOIL BEARING PRESSURE. FND BOLTS SHALL BE NOT LESS THAN 1/2" DIA. STEEL BOLTS EMBEDDED AT LEAST 1" INTO CONC \$ 15" INTO MASONRY, SPACED A MAX. OF 6'-0" O.C., W/ AT LEAST 2 BOLTS PER PLATE OR SILL & I BOLT WITHIN 12" OF ENDS & CORNERS,
- ORSC R403.1.6. FND DRAINAGE SHALL BE PROVIDED AROUND FND'S ENCLOSING HABITABLE OR USABLE SPACE BELOW GRADE, ORSC R405.1. SUB SURFACE FND. DRAINS SHALL BE CARRIED TO APPROVED DISPOSAL AREA OF CITY STORM
- 9. TYP. CONC FLR SLAB: 4" THICK CONC SLAB W/ \*4 @ 24" O.C. EA. WAY, AT 14" CLR. TOP SURFACE PLACE SLAB ON VAPOR BARRIER OVER COMPACTED GRANULAR BASE PER SPEC'S. PROVIDE CONTROL JOINTS PER DETAILS AT 20' MAX.
- SPACING. 10. ALL ROOF, YARD, & OTHER UPLAND SURFACE WATER MUST BE DIRECTED TO APPROVED DISPOSAL POINTS. UNDER NO CIRCUMSTANCES SHOULD STORM WATER BE LED INTO FND.
- HOLDOWN LOCATIONS INDICATED TO BE COORD. BY G.C. IN REGARD TO PLACEMENT IN CONC W/FRAMING. LOCATION TO
- BE COORD. W/ WIN. R.O. 12. MARK OUT PROPERTY LINES BEFORE CALLING FOR FND
- 13. FND WALLS SHALL EXTEND A MIN. OF 6' ABOYE THE FIN GRADE ADJ TO THE FND AT ALL POINTS, ORSC R404.16.
- 14. A GROUNDING ELECTRODE AT ELEC SERVICE IS REQ'D, CONSISTING OF (OR CONNECTED TO) A MIN. 20' LENGTH OF 1/2" DIA. STEEL REINF OF FTGS, ORSC SEC E35-250. ELECTRODE SHALL EXTEND 12" MIN. ABOVE THE PLATE LINE

### SAXTON RESIDENCE

45955 KINNIKINNICK DR. NESKOWIN, OR 97149

### SHEET INDEX

- A.I TITLE SHEET, SHEET INDEX
- A.2 SITE SURVEY A.3 SITE PLAN
- A.3.1 EXISTING SITE PLAN & PHOTOS A.4 FLOOR PLANS
- A.5 ROOF PLAN
- A.6 BUILDING ELEVATIONS
- A.7 BUILDING ELEVATIONS
- A.8 BUILDING SECTIONS A.9 ARCHITECTURAL DETAILS + SCHEDULES
- I.I INTERIOR ELEVATIONS 1.2 INTERIOR ELEVATIONS
- E.I ELECTRICAL PLANS

## **ABBREVIATIONS**

EΑ

ELEC

FS

GB


HM

HORIZ

HVAC

INSUL

GYP BD

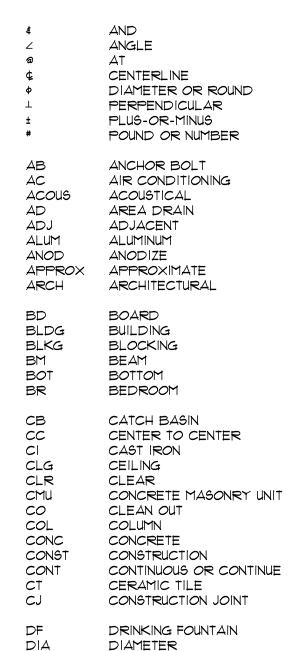

DIMENSION

DOWNSPOUT

DRAWINGS

DOOR

DETAIL

DIM

DR

DS

DTL

EXISTING EAST EACH ELEVATION EXPANSION JOINT ELECTRICAL ELECTRICAL PANEL EQUIPMENT CONTROL PLAN EXISTING EXTERIOR FIRE ALARM FLOOR DRAIN

E٩ EQ ESPCP EROSION, SEDIMENT, POLLUTION, EXIST  $E \times T$ FIRE EXTINGUISHER CABINET FINISH FLOOR FIRE HYDRANT FIN FINISH (ED) FLR FLOOR FND FOUNDATION FOB FACE OF BRICK FOC FACE OF CONCRETE FOF FACE OF FINISH FACE OF MASONRY FOM FOS FACE OF STUD FULL SIZE FTG FOOTING FUR FURRED (ING) FIRE & PRESSURE TREATED WOOD **FPSC** FIRE PROOF SELF CLOSING GΑ GAGE, GAUGE

GRAB BAR

HOSE BIB

GALYANIZED IRON

GYPSUM BOARD

HOLLOW CORE

HOLLOW METAL

HORIZONTAL

CONDITIONING

INSULATION

INTERIOR

INSIDE DIAMETER

NIC NO NTS 00 OD OHPR QŤ HEATING, VENTILATING, & AIR RA RB

RD

LAB LAM MAXMECH MED MFG MISC MO MTL MULL (N)

MECHANICAL MEDIUM METAL NEW NORTH PANEL

MANUFACTUR (ER) MANHOLE MINIMUM MISCELLANEOUS MASONRY OPENING MULLION NOT IN CONTRACT NUMBER NOT TO SCALE ON CENTER OUTSIDE DIAMETER OVERHANG PLATE LINE PLASTIC LAMINATE PLYWOOD POUNDS PER SQUARE INCH PRESSURE TREATED POLYVINYL CHLORIDE

QUARRY TILE

RETURN AIR

RUBBER BASE

REFRIGERATOR

ROOF DRAIN

RISER

JANITOR

KICK PLATE

LABORATORY

LAMINATE (D)

LAVATORY

MAXIMUM

LIGHT

JOINT

VCT VERT VEST WDW/O WP WSCT REINFORCE (D) (ING) REVISION (S), REVISED ROOM ROUGH OPENING

REY

RM

RO

SC SECT

SHWR SHT

SIM

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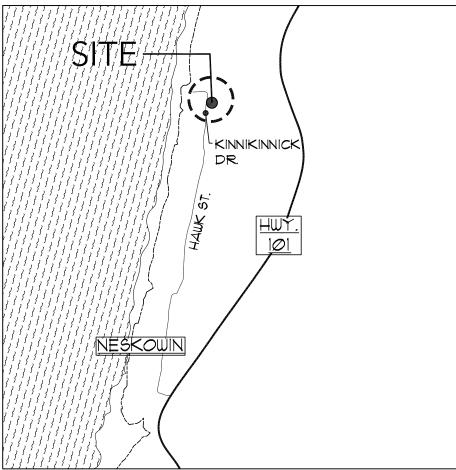
SOLID CORE SECTION SHOWER SHEET SIMILAR SPECS SPECIFICATIONS STAINLESS STEEL STANDARD STEEL STORAGE STRUCT STRUCTURAL TREAD TOP OF ASPHALT TO BE REMOVED TOP OF PLATE TOP OF CURB TELEPHONE

SOUTH


ΤA TBR T#G TONGUE AND GROOVE TISG TEMPERED INSULATED SAFETY GLASS TOC TOP OF CONCRETE TELEVISION TOW TOP OF WALL TWX TYP TELE-TYPEWRITER TYPICAL VINYL COMPOSITION TILE VERTICAL

VENEER PLASTER VESTIBULE WEST WITH WATER CLOSET WOODWATER HEATER WITHOUT WATERPROOF WAINSCOT

## VICINITY MAP



### LEGAL DESCRIPTION

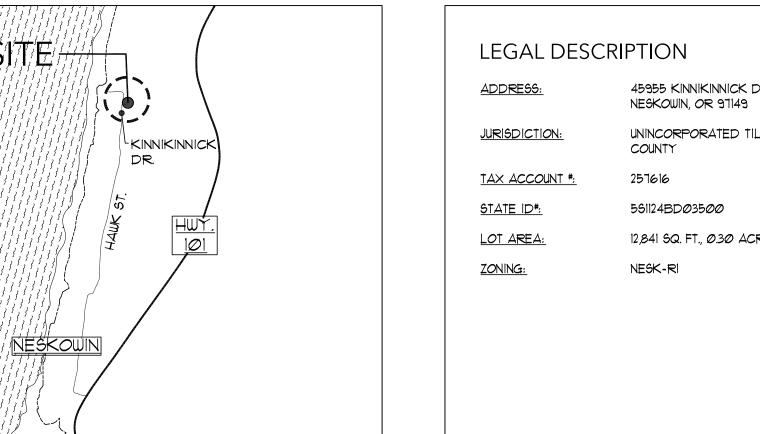

45955 KINNIKINNICK DR. UNINCORPORATED TILLAMOOK 12,841 SQ. FT., Ø.30 ACRES

## PROJECT TEAM

### PROJECT TEAM INFORMATION

STRUCTURAL: VISTA STRUCTURAL ENGINEERING, LLC 14718 NW DELIA STREET PORTLAND, OR 97229 503-737-5932


CONTACT: MARSHALL STOKES EMAIL: MARSHALL@VISTASTRUCTURAL.COM CONTRACTOR: WAND CONSTRUCTION, LLC 2180 NE REEF AVE.

LINCOLN CITY, OR 97367 541-921-4034 CONTACT: EMILE WAND EMAIL: WANDCONSTRUCTION@YAHOO.COM

SURVEYOR: DAVID LOOMIS SURVEYING 459 PIONEER MOUNTAIN LOOP TOLEDO, OR 97391 541-336-2994

CONTACT: DAVID LOOMIS EMAIL: DAVE@LOOMISSURVEYING.COM <u>OWNER:</u> RON & LYNNE SAXTON

> 2015 SE COLUMBIA RIVER DRIVE, UNIT 240 VANCOUVER, WA 98661 503-201-0894 CONTACT : LYNNE SAXTON EMAIL: LYNNESAXTONI@GMAIL.COM

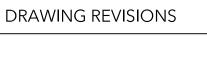

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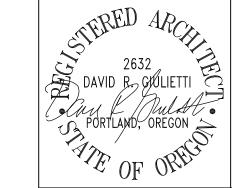
TEL: +1 503 223 0325 WWW.GSWARCHITECTS.NET

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DRAWING TITLE

TITLE SHEET

SHEET INDEX





DATE: JUNE 29, 2021

DRAWING NO:

JOB NO: #202024

SCALE:

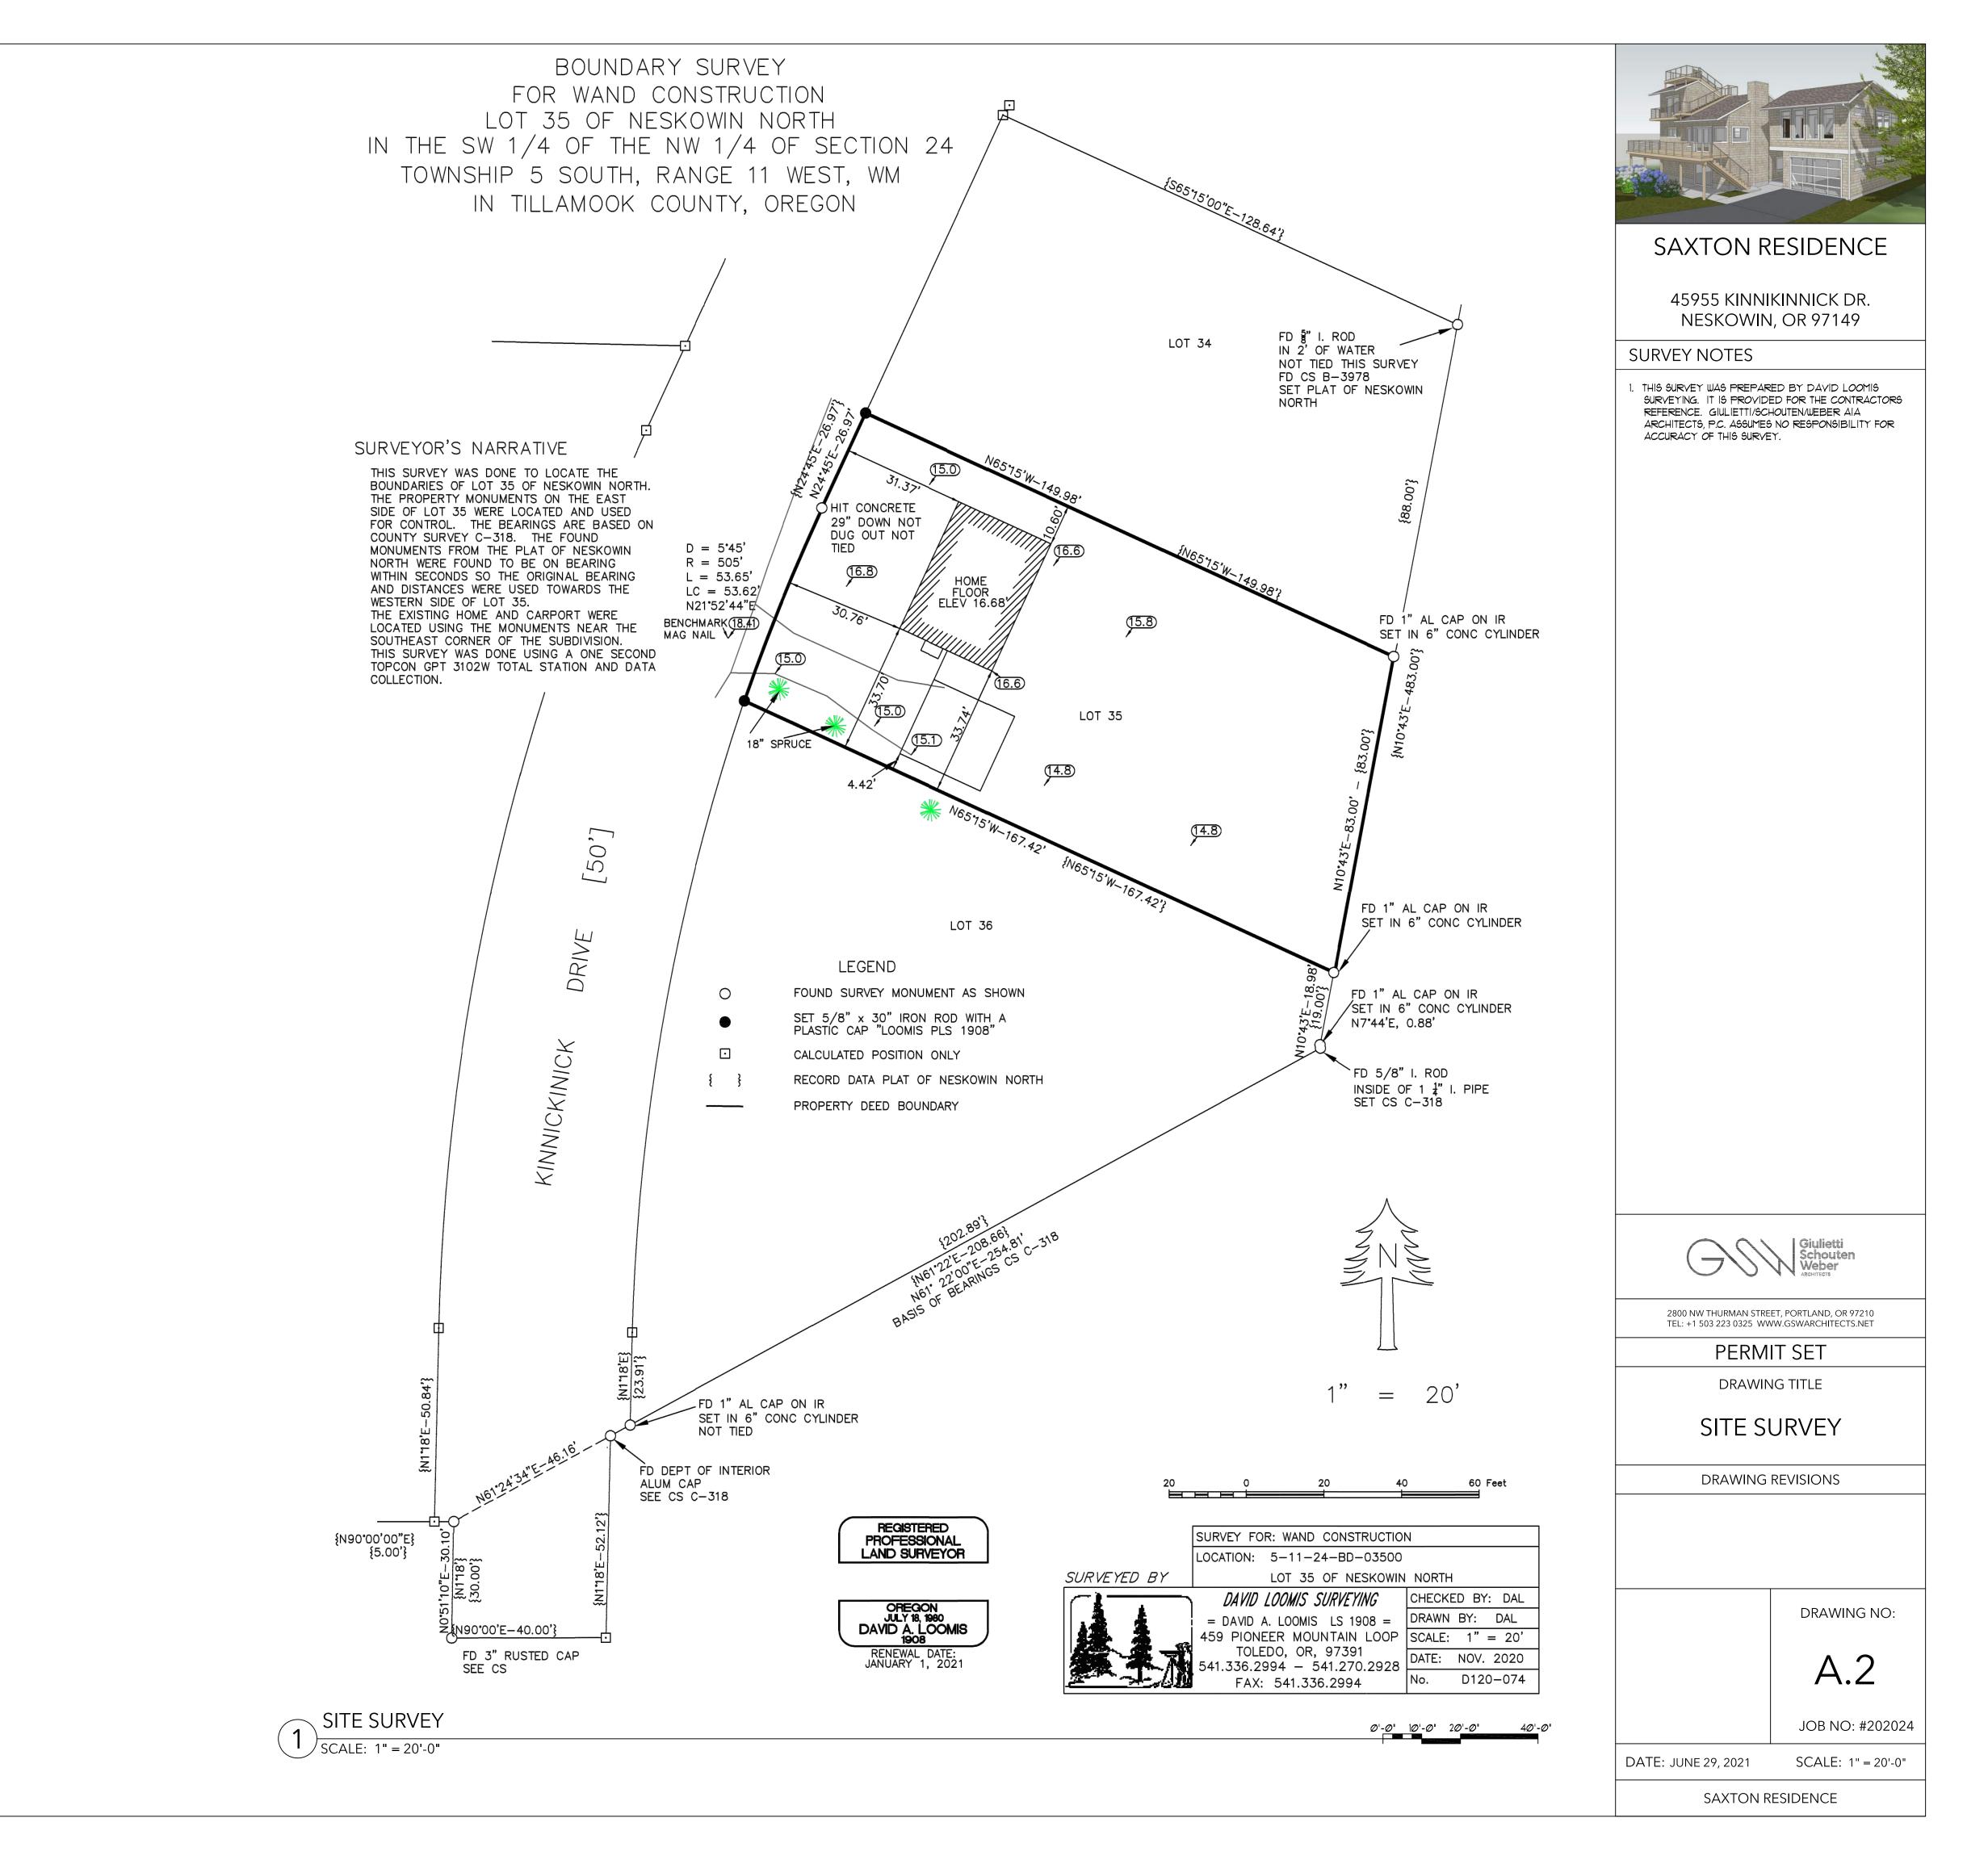

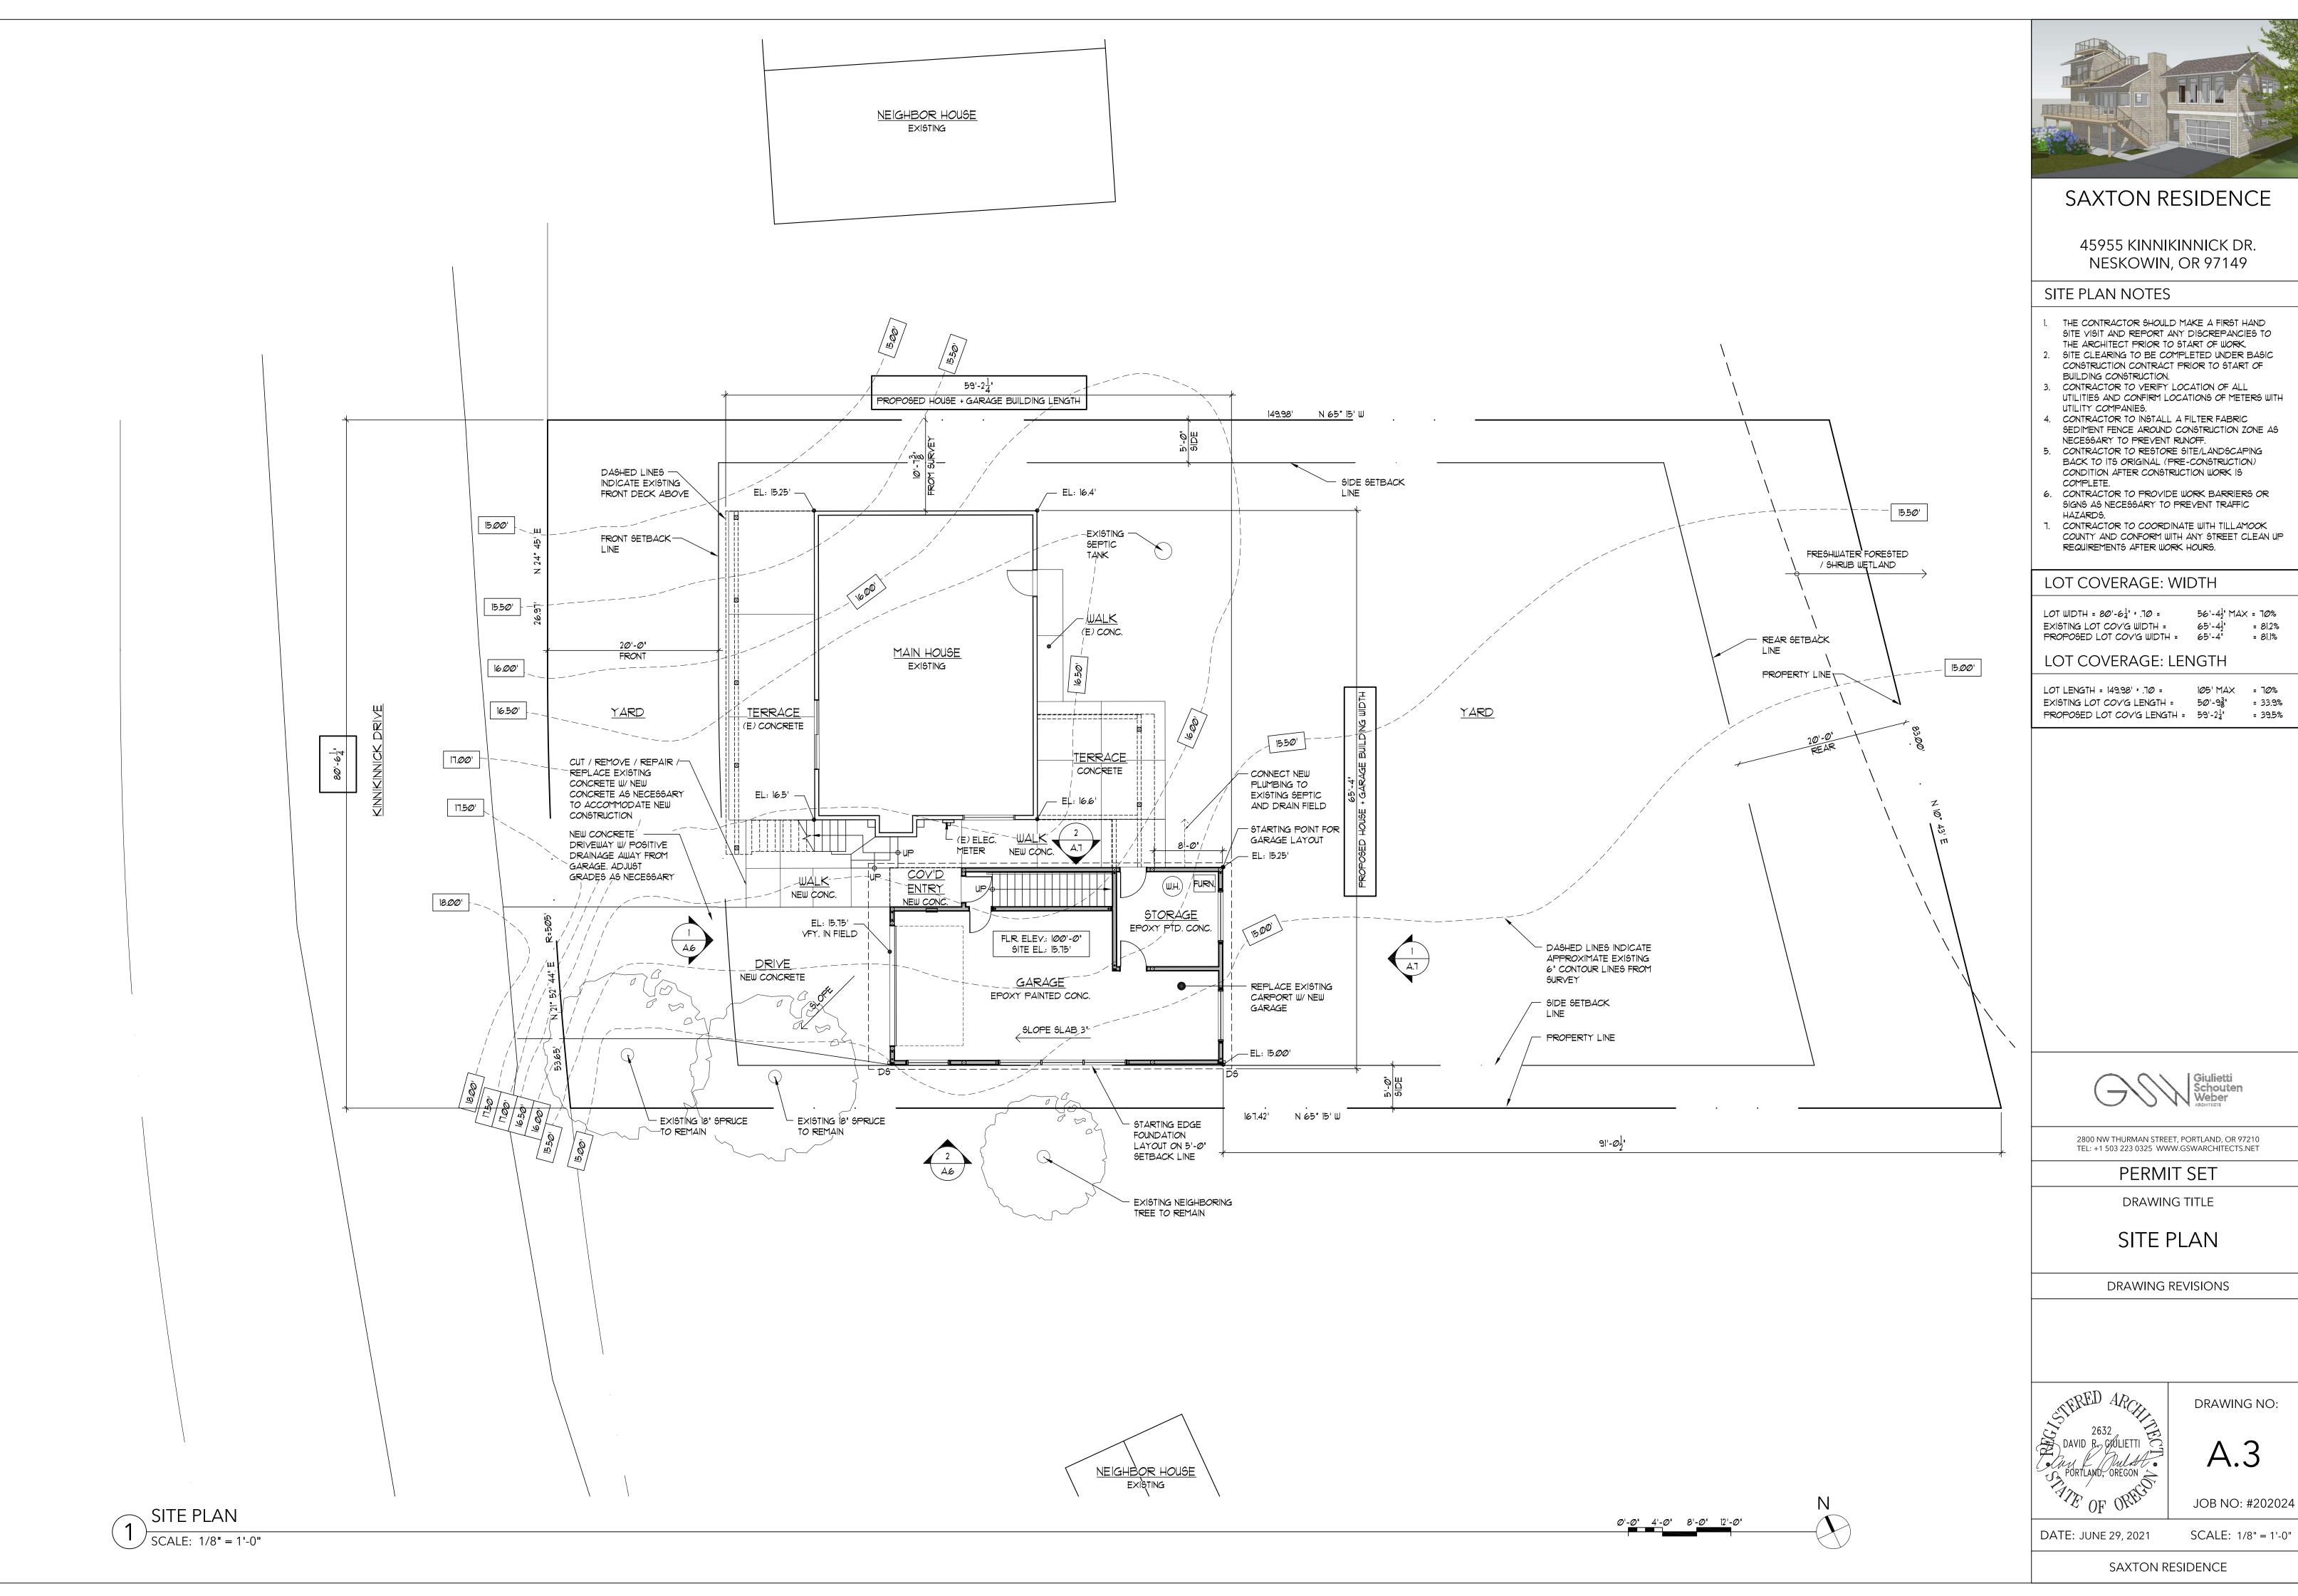



### SAXTON RESIDENCE

45955 KINNIKINNICK DR.

- THE CONTRACTOR SHOULD MAKE A FIRST HAND SITE VISIT AND REPORT ANY DISCREPANCIES TO
- THE ARCHITECT PRIOR TO START OF WORK. SITE CLEARING TO BE COMPLETED UNDER BASIC
- CONTRACTOR TO VERIFY LOCATION OF ALL UTILITIES AND CONFIRM LOCATIONS OF METERS WITH
- CONTRACTOR TO INSTALL A FILTER FABRIC SEDIMENT FENCE AROUND CONSTRUCTION ZONE AS NECESSARY TO PREVENT RUNOFF.
- CONTRACTOR TO RESTORE SITE/LANDSCAPING BACK TO ITS ORIGINAL (PRE-CONSTRUCTION) CONDITION AFTER CONSTRUCTION WORK IS
- 6. CONTRACTOR TO PROVIDE WORK BARRIERS OR SIGNS AS NECESSARY TO PREVENT TRAFFIC
- CONTRACTOR TO COORDINATE WITH TILLAMOOK COUNTY AND CONFORM WITH ANY STREET CLEAN UP

LOT WIDTH =  $80'-6\frac{1}{4}$ \*  $10 = 56'-4\frac{1}{2}$ " MAX = 10%EXISTING LOT COV'G WIDTH =  $65'-4\frac{1}{2}''$  = 81.2% PROPOSED LOT COV'G WIDTH = 65'-4'' = 81.1%

105' MAX = 70% EXISTING LOT COV'G LENGTH =  $50'-9\frac{3}{8}$ " = 33.9% PROPOSED LOT COY'G LENGTH =  $59'-2\frac{1}{4}"$ = 39.5%

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DRAWING NO:

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**EXISTING HOUSE** 



EXISTING CARPORT




PARTIAL EXISTING SITE PLAN

<sup>)</sup> SCALE: 1/8" = 1'-0"

EXISTING DRIVE TO CARPORT



EXISTING CARPORT - FRONT

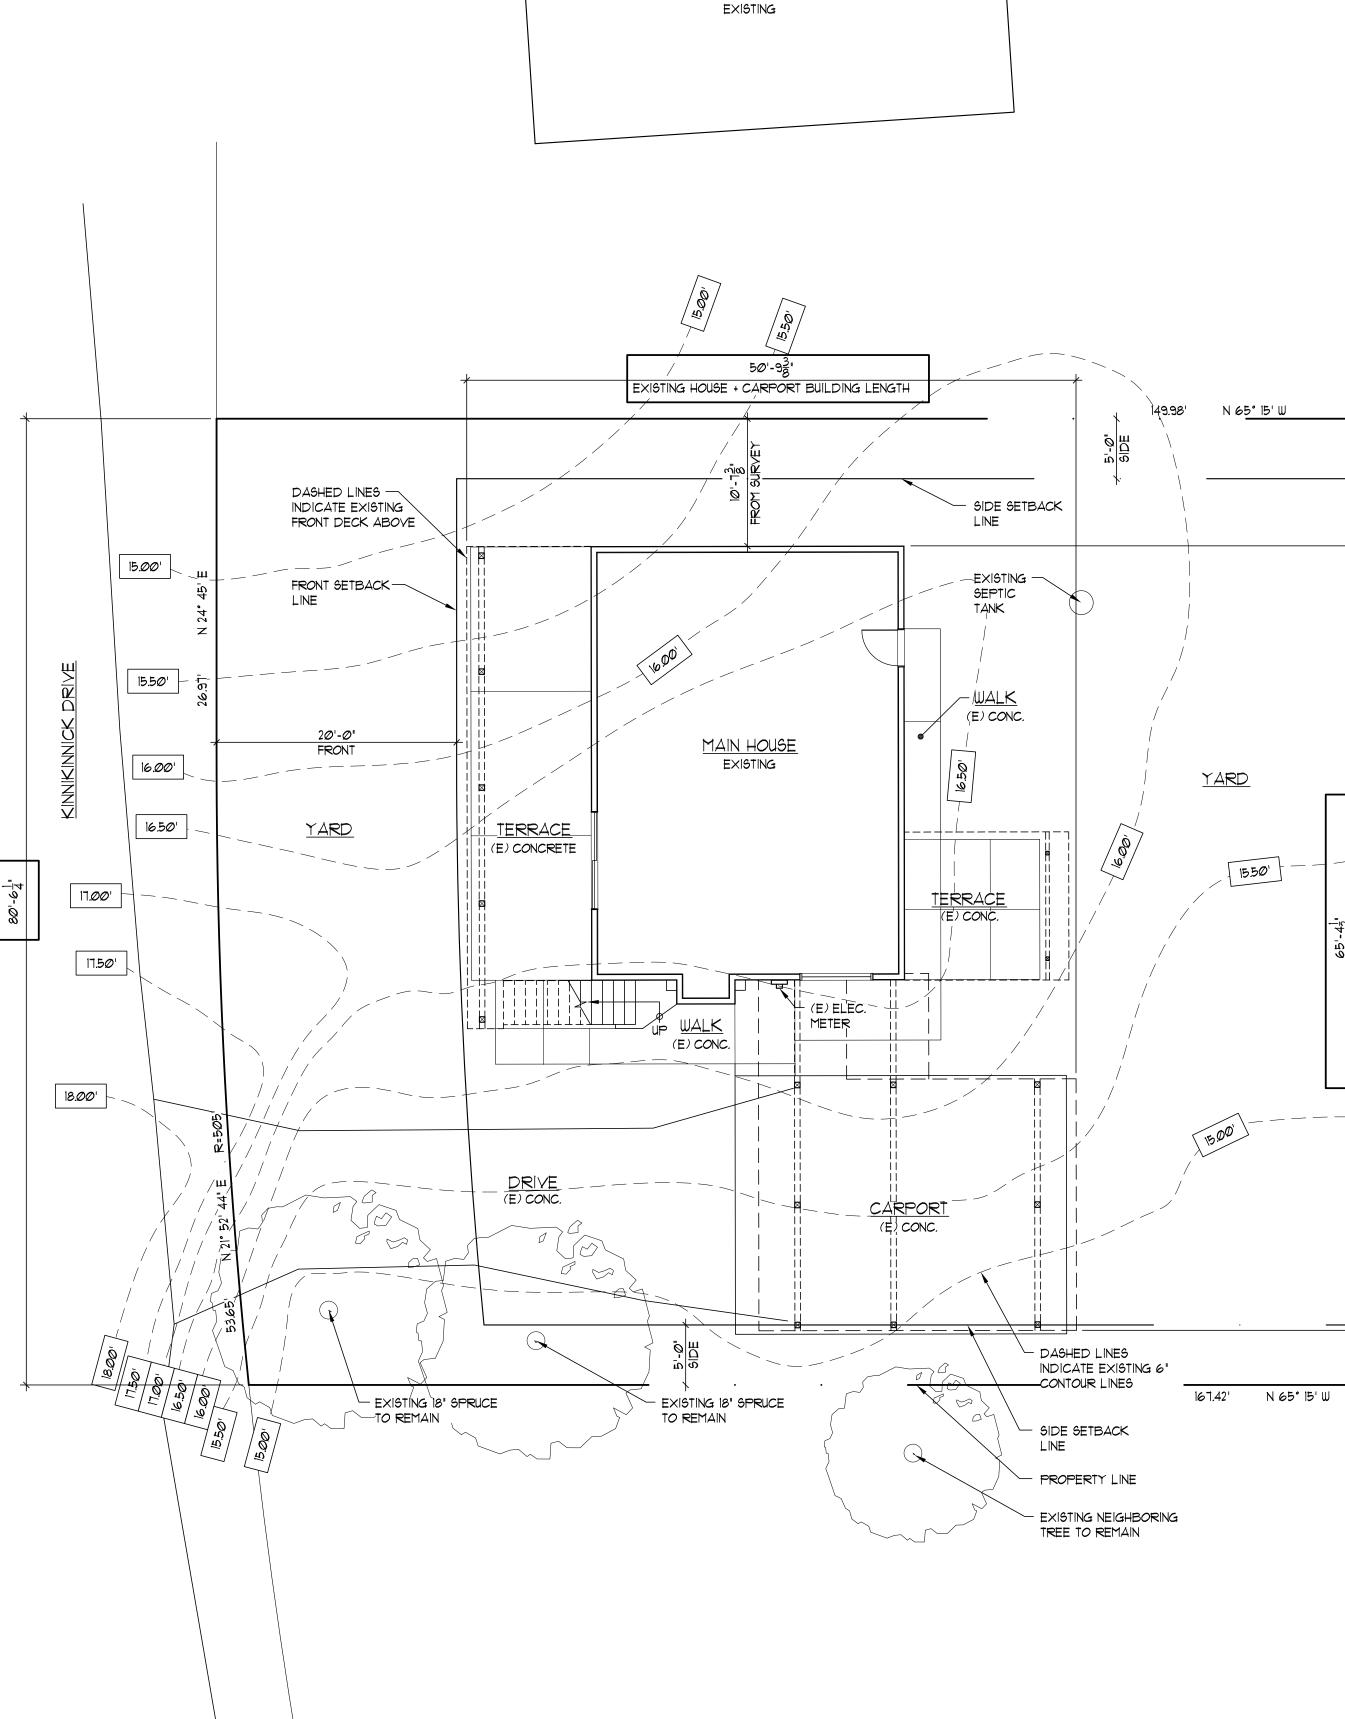

NEIGHBOR HOUSE



### SAXTON RESIDENCE

45955 KINNIKINNICK DR. NESKOWIN, OR 97149

### SITE PLAN NOTES

- THE CONTRACTOR SHOULD MAKE A FIRST HAND SITE VISIT AND REPORT ANY DISCREPANCIES TO THE ARCHITECT PRIOR TO START OF WORK.
- 2. SITE CLEARING TO BE COMPLETED UNDER BASIC CONSTRUCTION CONTRACT PRIOR TO START OF BUILDING CONSTRUCTION.

  3. CONTRACTOR TO VERIEX LOCATION OF ALL.
- 3. CONTRACTOR TO VERIFY LOCATION OF ALL UTILITIES AND CONFIRM LOCATIONS OF METERS WITH UTILITY COMPANIES.
- 4. CONTRACTOR TO INSTALL A FILTER FABRIC SEDIMENT FENCE AROUND CONSTRUCTION ZONE AS NECESSARY TO PREVENT RUNOFF.

  5. CONTRACTOR TO RESTORE SITE/LANDSCAPING BACK TO ITS ORIGINAL (PRE-CONSTRUCTION)
- COMPLETE.

  6. CONTRACTOR TO PROVIDE WORK BARRIERS OR SIGNS AS NECESSARY TO PREVENT TRAFFIC

CONDITION AFTER CONSTRUCTION WORK IS

HAZARDS.

1. CONTRACTOR TO COORDINATE WITH TILLAMOOK
COUNTY AND CONFORM WITH ANY STREET CLEAN UP

REQUIREMENTS AFTER WORK HOURS.

### EXISTING PLAN NOTES

1. EXISTING PLANS ARE PROVIDED FOR THE CONTRACTORS REFERENCE. THE CONTRACTOR SHALL VISIT THE SITE AND MAKE FIRST HAND INSPECTION OF THE PREMISES AND REPORT ANY DISCREPANCIES TO THE ARCHITECT PRIOR TO AND DURING CONSTRUCTION.

#### EXISTING PHOTOS

I. EXISTING PHOTOS ARE PROVIDED FOR THE CONTRACTOR'S REFERENCE. THE CONTRACTOR SHALL VISIT THE SITE AND MAKE FIRST HAND INSPECTION OF THE PREMISES AND REPORT ANY DISCREPANCIES TO THE ARCHITECT.

### LOT COVERAGE: WIDTH

LOT WIDTH =  $80' - 6\frac{1}{4}" * .70 = 56' - 4\frac{1}{2}" MAX = 70%$ EXISTING LOT COV'G WIDTH =  $65' - 4\frac{1}{2}" = 81.2\%$ PROPOSED LOT COV'G WIDTH = 65' - 4" = 81.1%

### LOT COVERAGE: LENGTH

LOT LENGTH = 149.98' \* .70 = 105' MAX = 70%EXISTING LOT COV'G LENGTH =  $50'-9_8^2" = 33.9\%$ PROPOSED LOT COV'G LENGTH =  $59'-2_4^1" = 39.5\%$ 



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# EXISTING SITE PLAN & EXISTING PHOTOS

DRAWING REVISIONS



NEIGHBOR HOUSE Existing DRAWING NO:

A.3.1


JOB NO: #202024

DATE: JUNE 29, 2021 SCALE: 1/8" = 1'-0"

SAXTON RESIDENCE



EXISTING CARPORT TO HOUSE CONNECTION

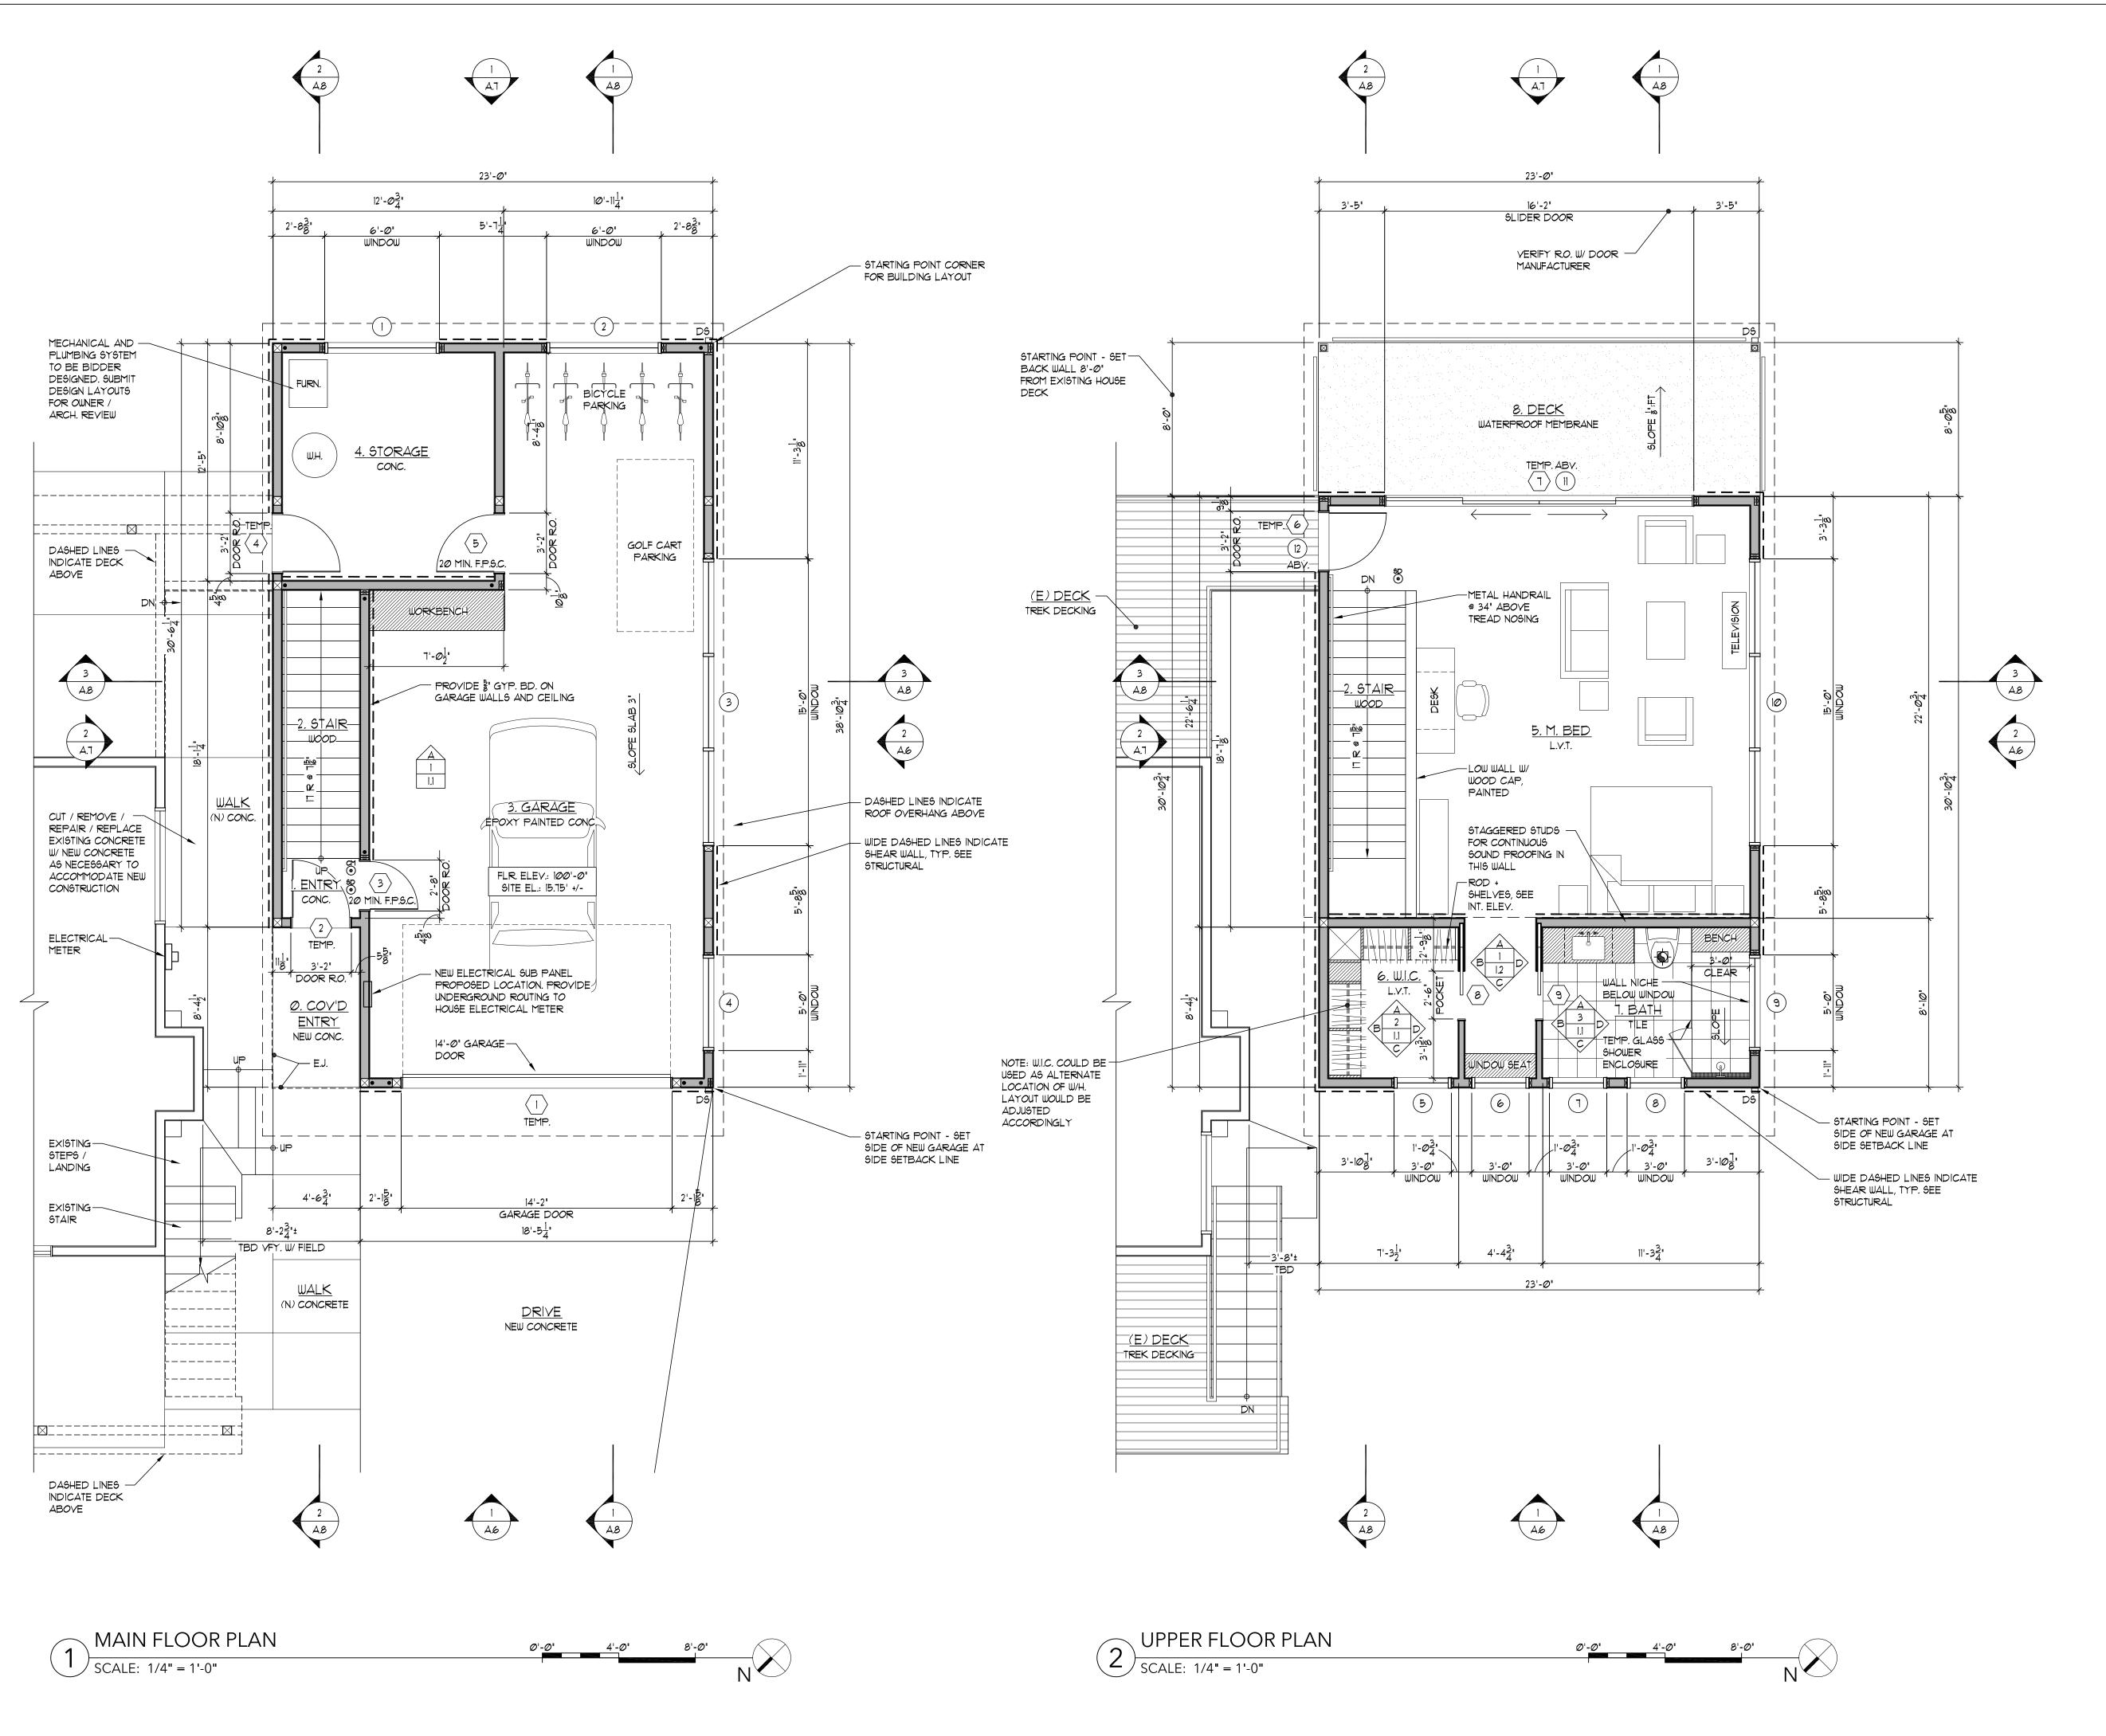



### SAXTON RESIDENCE

45955 KINNIKINNICK DR. NESKOWIN, OR 97149

### FLOOR PLAN NOTES

- 1. ALL DIMENSIONS ARE TO FACE OF STUD (F.O.S.) UNLESS NOTED OTHERWISE.
- 2. ALL EXTERIOR WALLS TO USE 2X6 WOOD STUDS 16" O.C. UNLESS NOTED OTHERWISE. ALL INTERIOR WALLS TO BE
- 2X4 WOOD STUDS 16" O.C. UNLESS NOTED OTHERWISE.

  3. ALL SLEEPING ROOMS SHALL BE PROVIDED WITH EMERGENCY EGRESS OPENINGS, ORSC SEC. R310. CONTRACTOR 15 RESPONSIBLE FOR MAKING SURE THAT ALL SLEEPING ROOMS TO BE PROVIDED W/EGRESS WINDOW WHETHER OR NOT INDICATED ON
- DRAWINGS/SCHEDULE.

  4. CONTRACTOR IS RESPONSIBLE FOR INSTALLING TEMPERED GLASS IN ALL LOCATIONS AS REQUIRED BY CODE WHETHER OR NOT INDICATED AS TEMPERED ON DRAWINGS/SCHEDULE. SAFETY GLAZING SHALL BE PROVIDED IN ACCORDANCE WITH ORSC R308.4: A. AT TUBS OR SHOWERS WHERE THE GLAZING IS LESS THAN 60" ABOVE THE DRAIN, B. WITHIN 24" OF A DOOR AND LESS

THAN 60" ABOVE THE FLOOR, C. PANES GREATER THAN 9

- 6Q. FT. AND LESS THAN 18' ABOVE THE FLOOR.
  5. ALL HANDRAILS AND GUARDRAILS SHALL MEET REQUIREMENTS OF ORSC SEC. R311 AND R312. A HANDRAIL IS REQUIRED AT EVERY STAIR OF 3 OR MORE RISERS. PROVIDED A 1.5'-2-5/8' DIAMETER RAIL WITH 1.5" MIN. BETWEEN HANDRAIL AND WALL AND MOUNTED AT +30'-38' ABOVE THE TREAD NOSING, ORSC R311.7.1. HANDRAILS WHICH FUNCTION AS GUARDS SHALL BE 34'-38' ABOVE THE TREAD NOSING, ORSC R311.7.8.3.
- 6. PROVIDE 110 Y INTERCONNECTED SMOKE
  DETECTORS/CARBON MONOXIDE ALARMS WITH BATTERY
  BACKUP AT ALL FLOOR LEVELS, ORSC SEC. R314 @ R315.
  SMOKE DETECTORS/CARBON MONOXIDE ALARMS TO BE
  INSTALLED IN EACH SLEEPING ROOM, OUTSIDE OF EACH
  SEPARATE SLEEPING AREA IN THE IMMEDIATE VICINITY OF
  THE BEDROOMS.
- . ALL BATHROOMS TO HAVE EXHAUST FAN TO EXTERIOR (80 CFM FOR BATHING FACILITIES/ 50 CFM FOR TOILET AND LAVATORY ONLY) ORSC R303.3 CONTROLLED BY A DE-HUMIDISTAT, TIMER OR SIMILAR AUTO. CONTROL.
- ALL GYP. BD. WALLS TO HAVE A SMOOTH FINISH (LEVEL 4. UNLESS NOTED OTHERWISE.
   GLAZING SHALL BE INSTALLED AS REQ'D BY ORSC SEC.
- R308. ALL WINDOWS TO MEET CLASS U=0.30. ALL EXTERIOR DOORS OTHER THAN THE MAIN ENTRY TO MEET CLASS U=0.20. ENTRY DOOR TO HAVE A U=.54 W/ A MAX. AREA OF 24 SQ. FT.
- 10. PROVIDE CARBON MONOXIDE DETECTOR INSIDE OF DOOR TO THE HOUSE FROM THE GARAGE.
- II. I/2" GYP. BOARD IS REQ'D AT THE SEPARATION WALL BETWEEN GARAGE AND RESIDENCE, ORSC R3026
   A 1-3/8" MIN. SOLID CORE DOOR OR A 20-MINUTE RATED
- FIRE DOOR IS REQUIRED AT THE SEPARATION WALL BETWEEN GARAGE AND RESIDENCE, ORSC R302.5.1.1.

  13 MIN 5/8" TYPE-X GYP BOARD IS REQ'D ON THE GAR.
- 13. MIN. 5/8" TYPE-X GYP. BOARD IS REQ'D ON THE GARAGE CEILING AND ALL SUPPORTING WALLS WHEN LIVING AREAS ARE ABOVE.
- 14. EXTERIOR POSTS SHALL BE APPROVED DECAY-RESISTANT / PRESSURE-TREATED WOOD, SHALL PROJECT 2" MIN. ABOVE GRADE AND BE SEPARATED BY AN IMPERVIOUS MOISTURE BARRIER, ORSC R317.1.4

  15. A 2'-0" MIN. DOOR WIDTH IS REQ'D AT WATER HEATERS,
- ORSC P2811.0.

  16. THE MAXIMUM AMOUNT OF WATER USED BY NEW PLUMBING FIXTURES MAY NOT EXCEED THE FOLLOWING: TOILETS, 1.6
- GAL. PER FLUSH± OPSC P2702.0.

  17. SHOWERS MUST BE A MINIMUM OF 1,024 SQ. IN. AND SHALL

  BE CAPABLE OF ENCOMPASSING A 30' CIRCLE. OPSC

  R307.1.




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FLOOR PLANS

DRAWING REVISIONS





Λ *1* 


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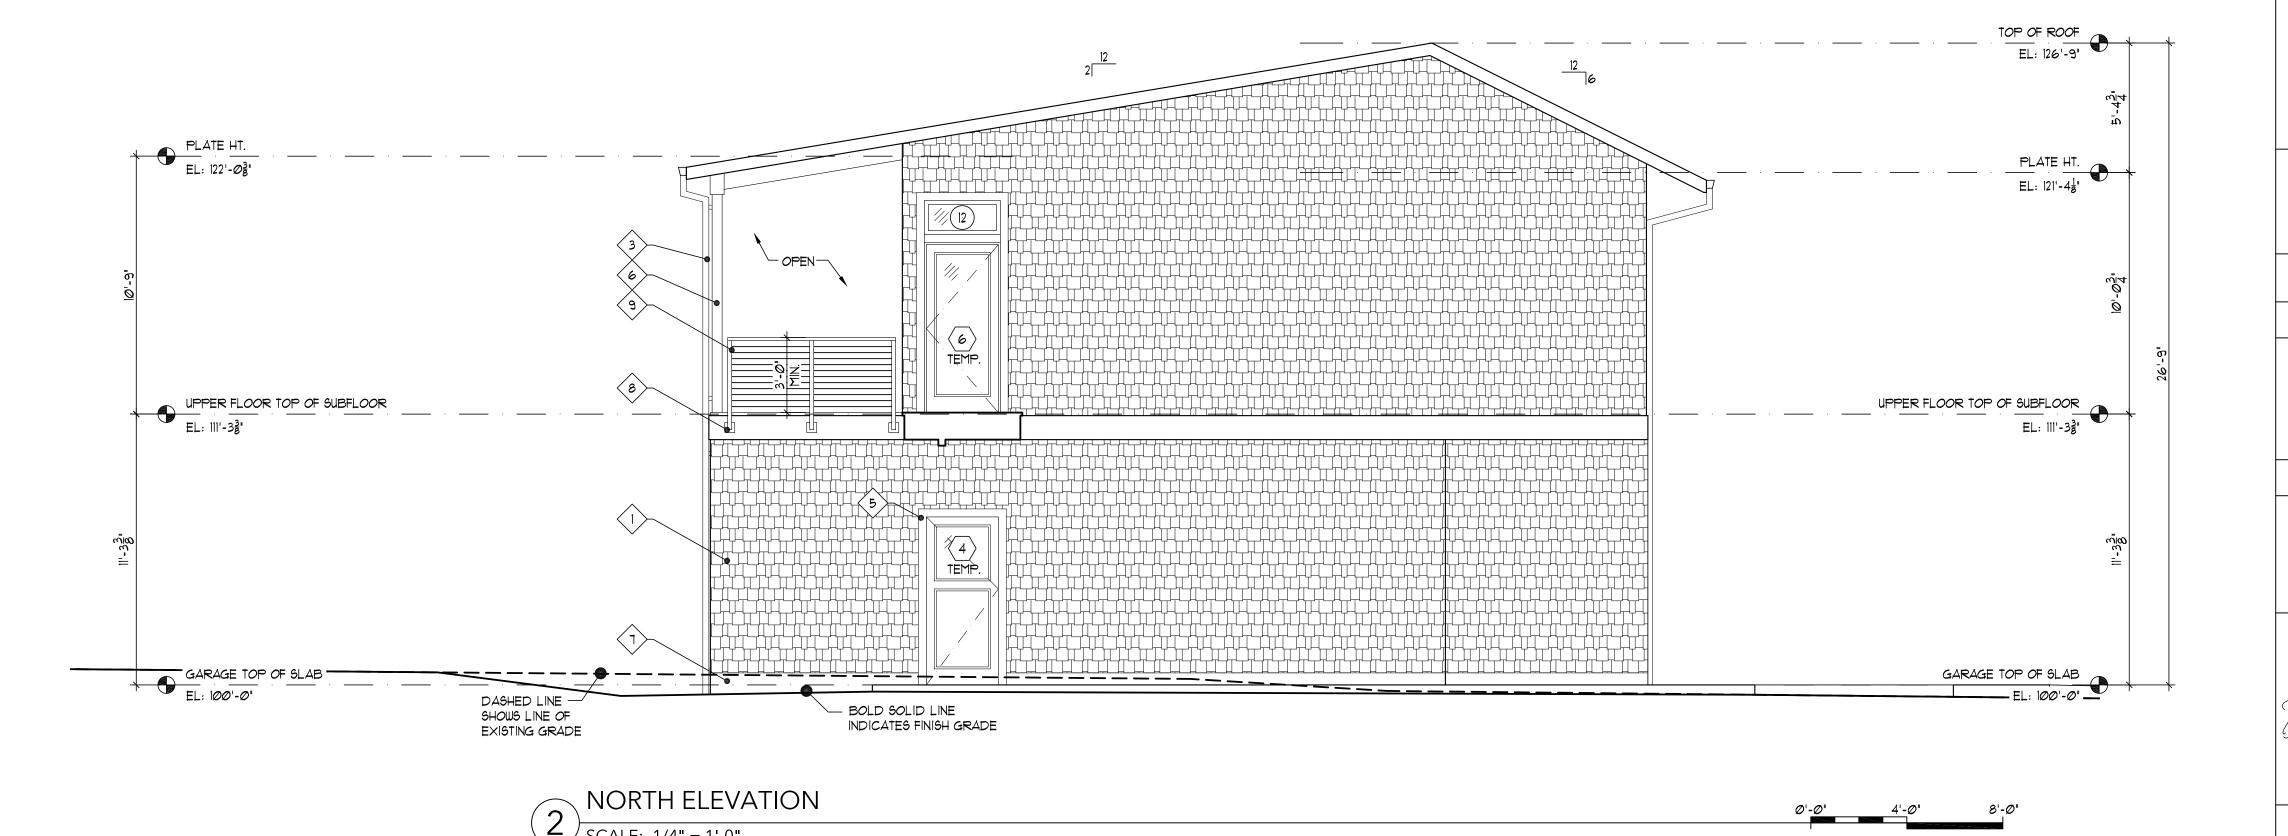
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### SAXTON RESIDENCE

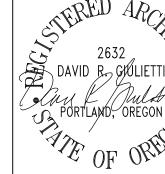45955 KINNIKINNICK DR. NESKOWIN, OR 97149

### ELEVATION NOTES

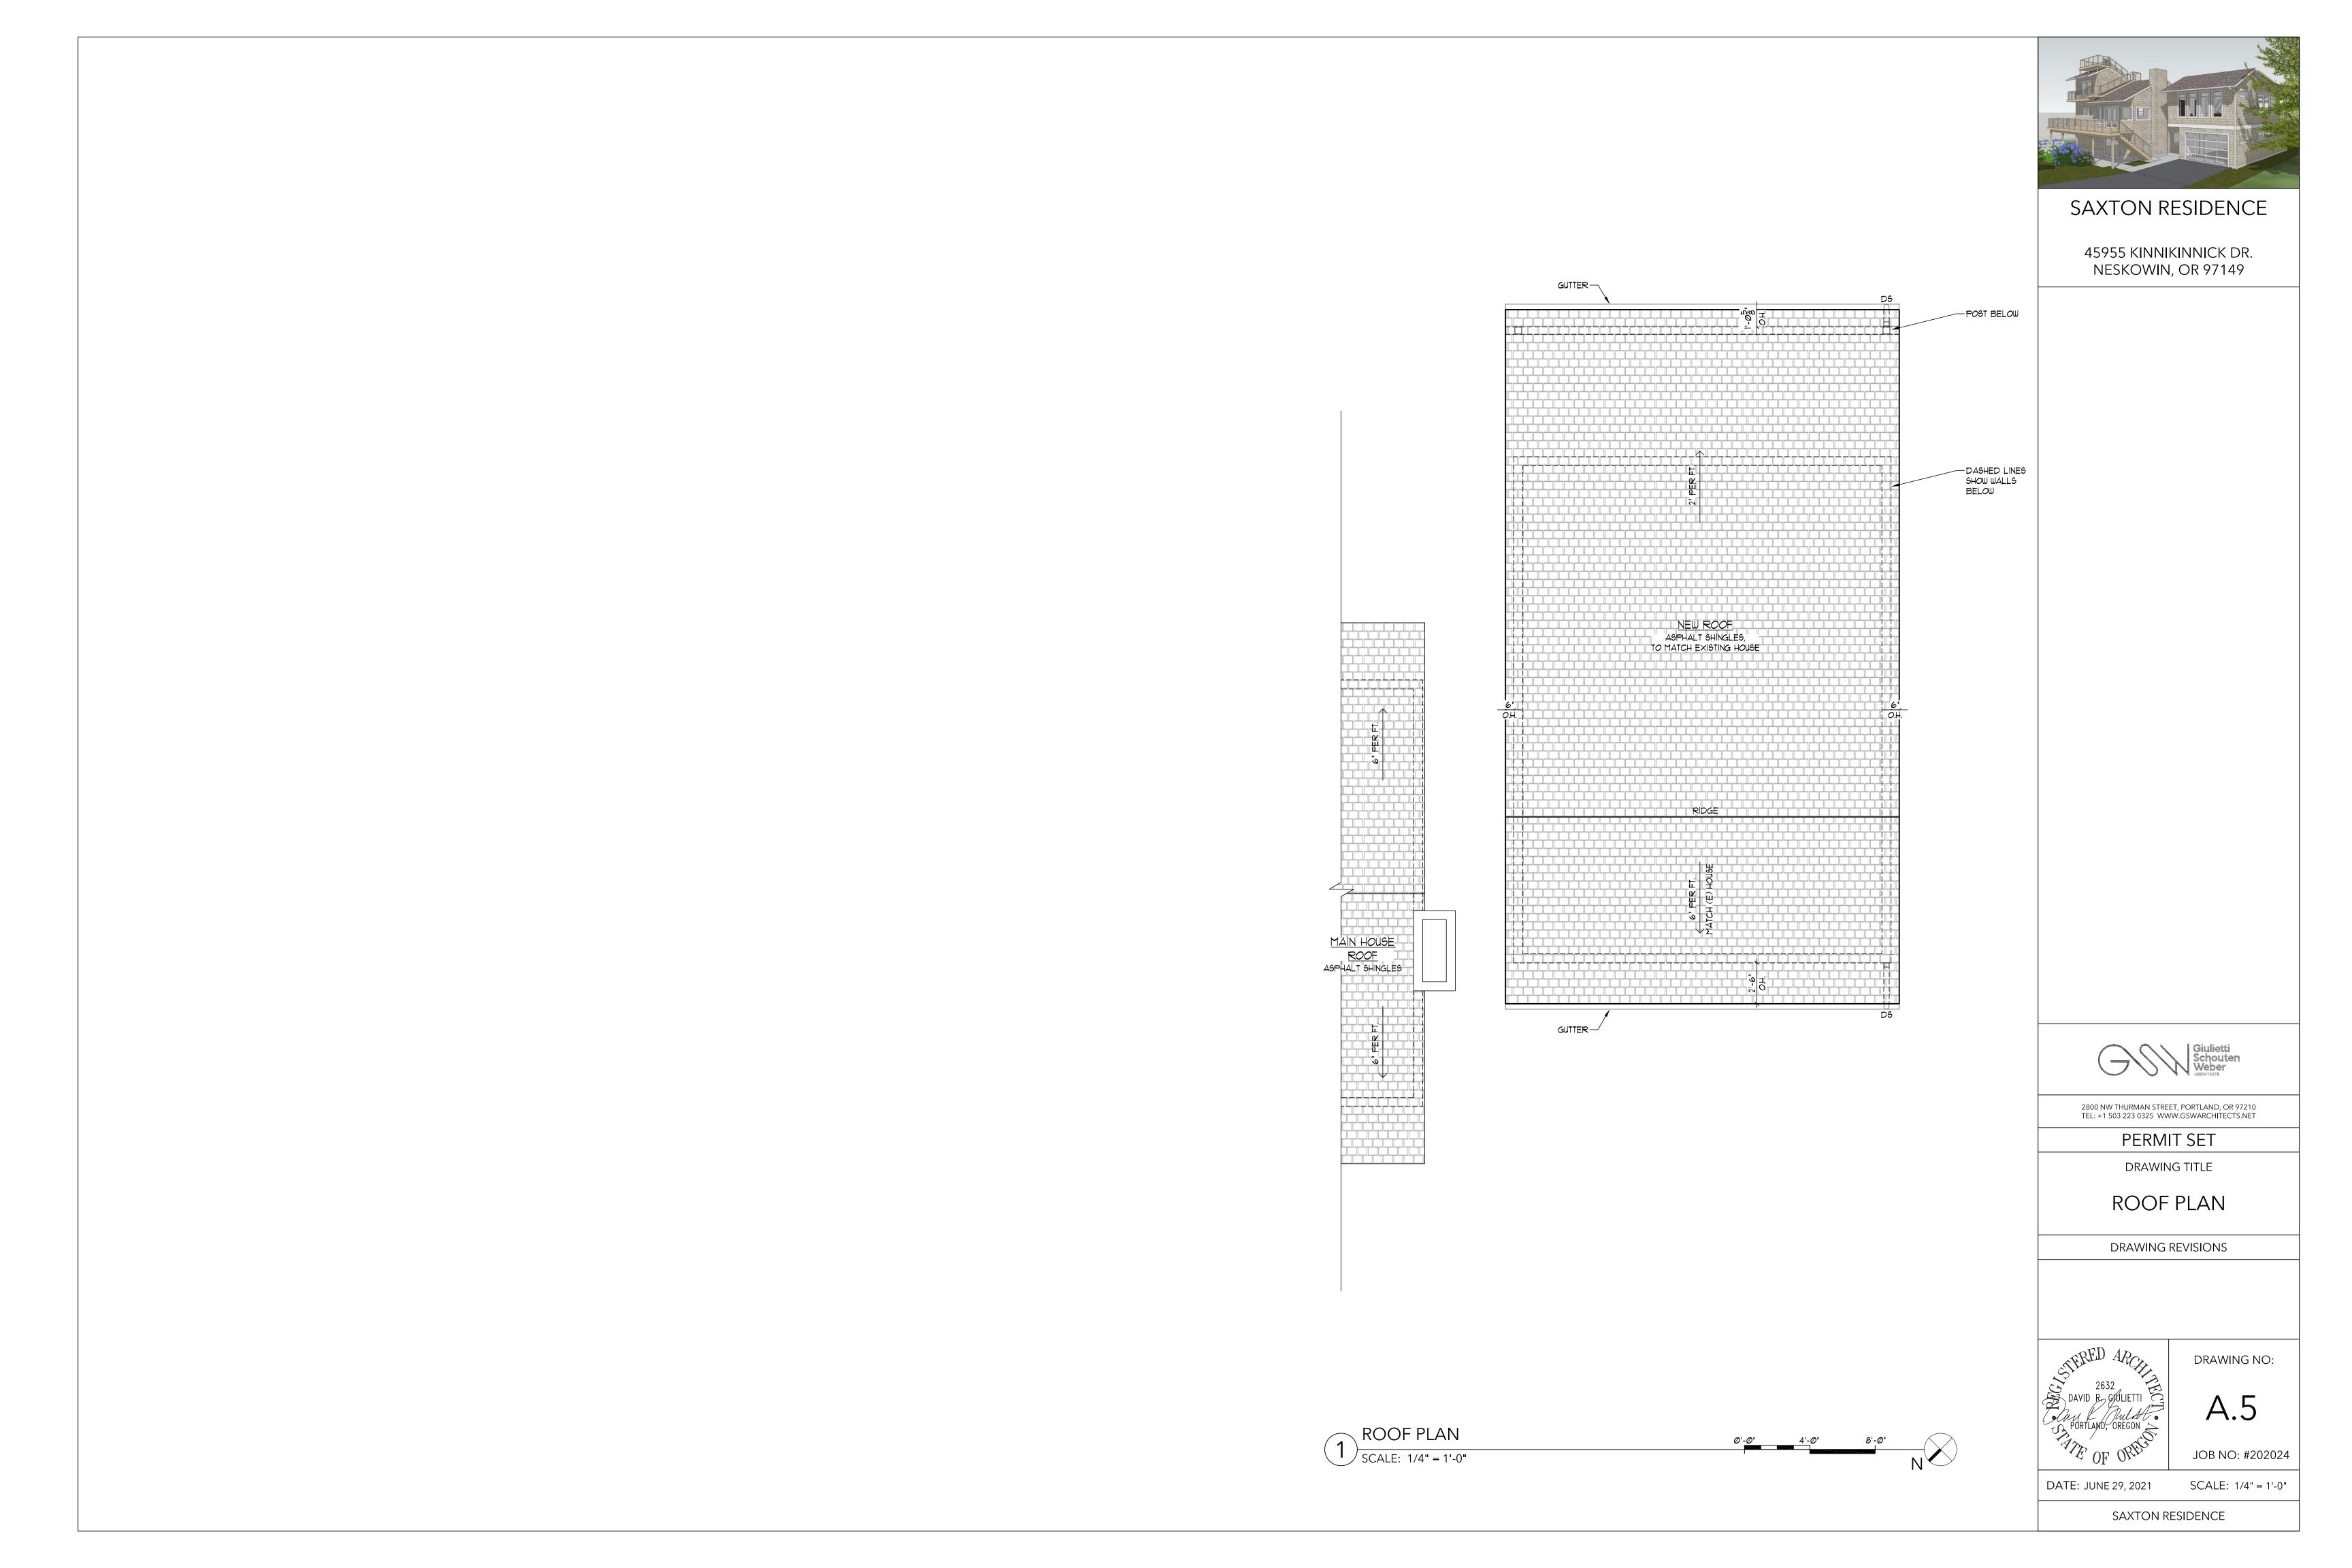- UDOD SHINGLE SIDING TO MATCH SIDING AT EXISTING HOUSE, STAINED.
- (2) FIBERGLASS BASE ASPHALT ROOF SHINGLES TO MATCH EXISTING HOUSE SHINGLES. 25 YEAR WARRANTY. COLOR TO "BE SELECTED BY ARCHITECT OR TO MATCH EXISTING". PROVIDE 'ICE+WATER' SHIELD MEMBRANE 2:12 SIDE OF SLOPED ROOF
- (3) PRIMED EXTRUDED GUTTERS AND DOWNSPOUTS. PAINTED TO MATCH FASCIA BOARDS. FASCIA BOARDS TO BE PAINTED PRIOR TO GUTTER INSTALLATION.
- 4 2X FASCIA BOARD, PAINTED TO MATCH FASCIAS AT EXISTING HOUSE.
- (5) DOOR OR WINDOW TRIM, WOOD PAINTED.
- (6) WOOD POST
- <1> CONCRETE. MAINTAIN MINIMUM 6" CLEARANCE FROM WOOD SIDING TO GRADE, TYPICAL.
- 2X CEDAR, PAINTED TRIM BOARD TO MATCH ACCENT COLOR OF HOUSE. EXTEND ONTO EXISTING REAR DECK FASCIA
- 9 STAINLESS STEEL HANDRAILS AND GUARDRAILS
- (10) MILGARD FIBERGLASS WINDOW SYSTEM
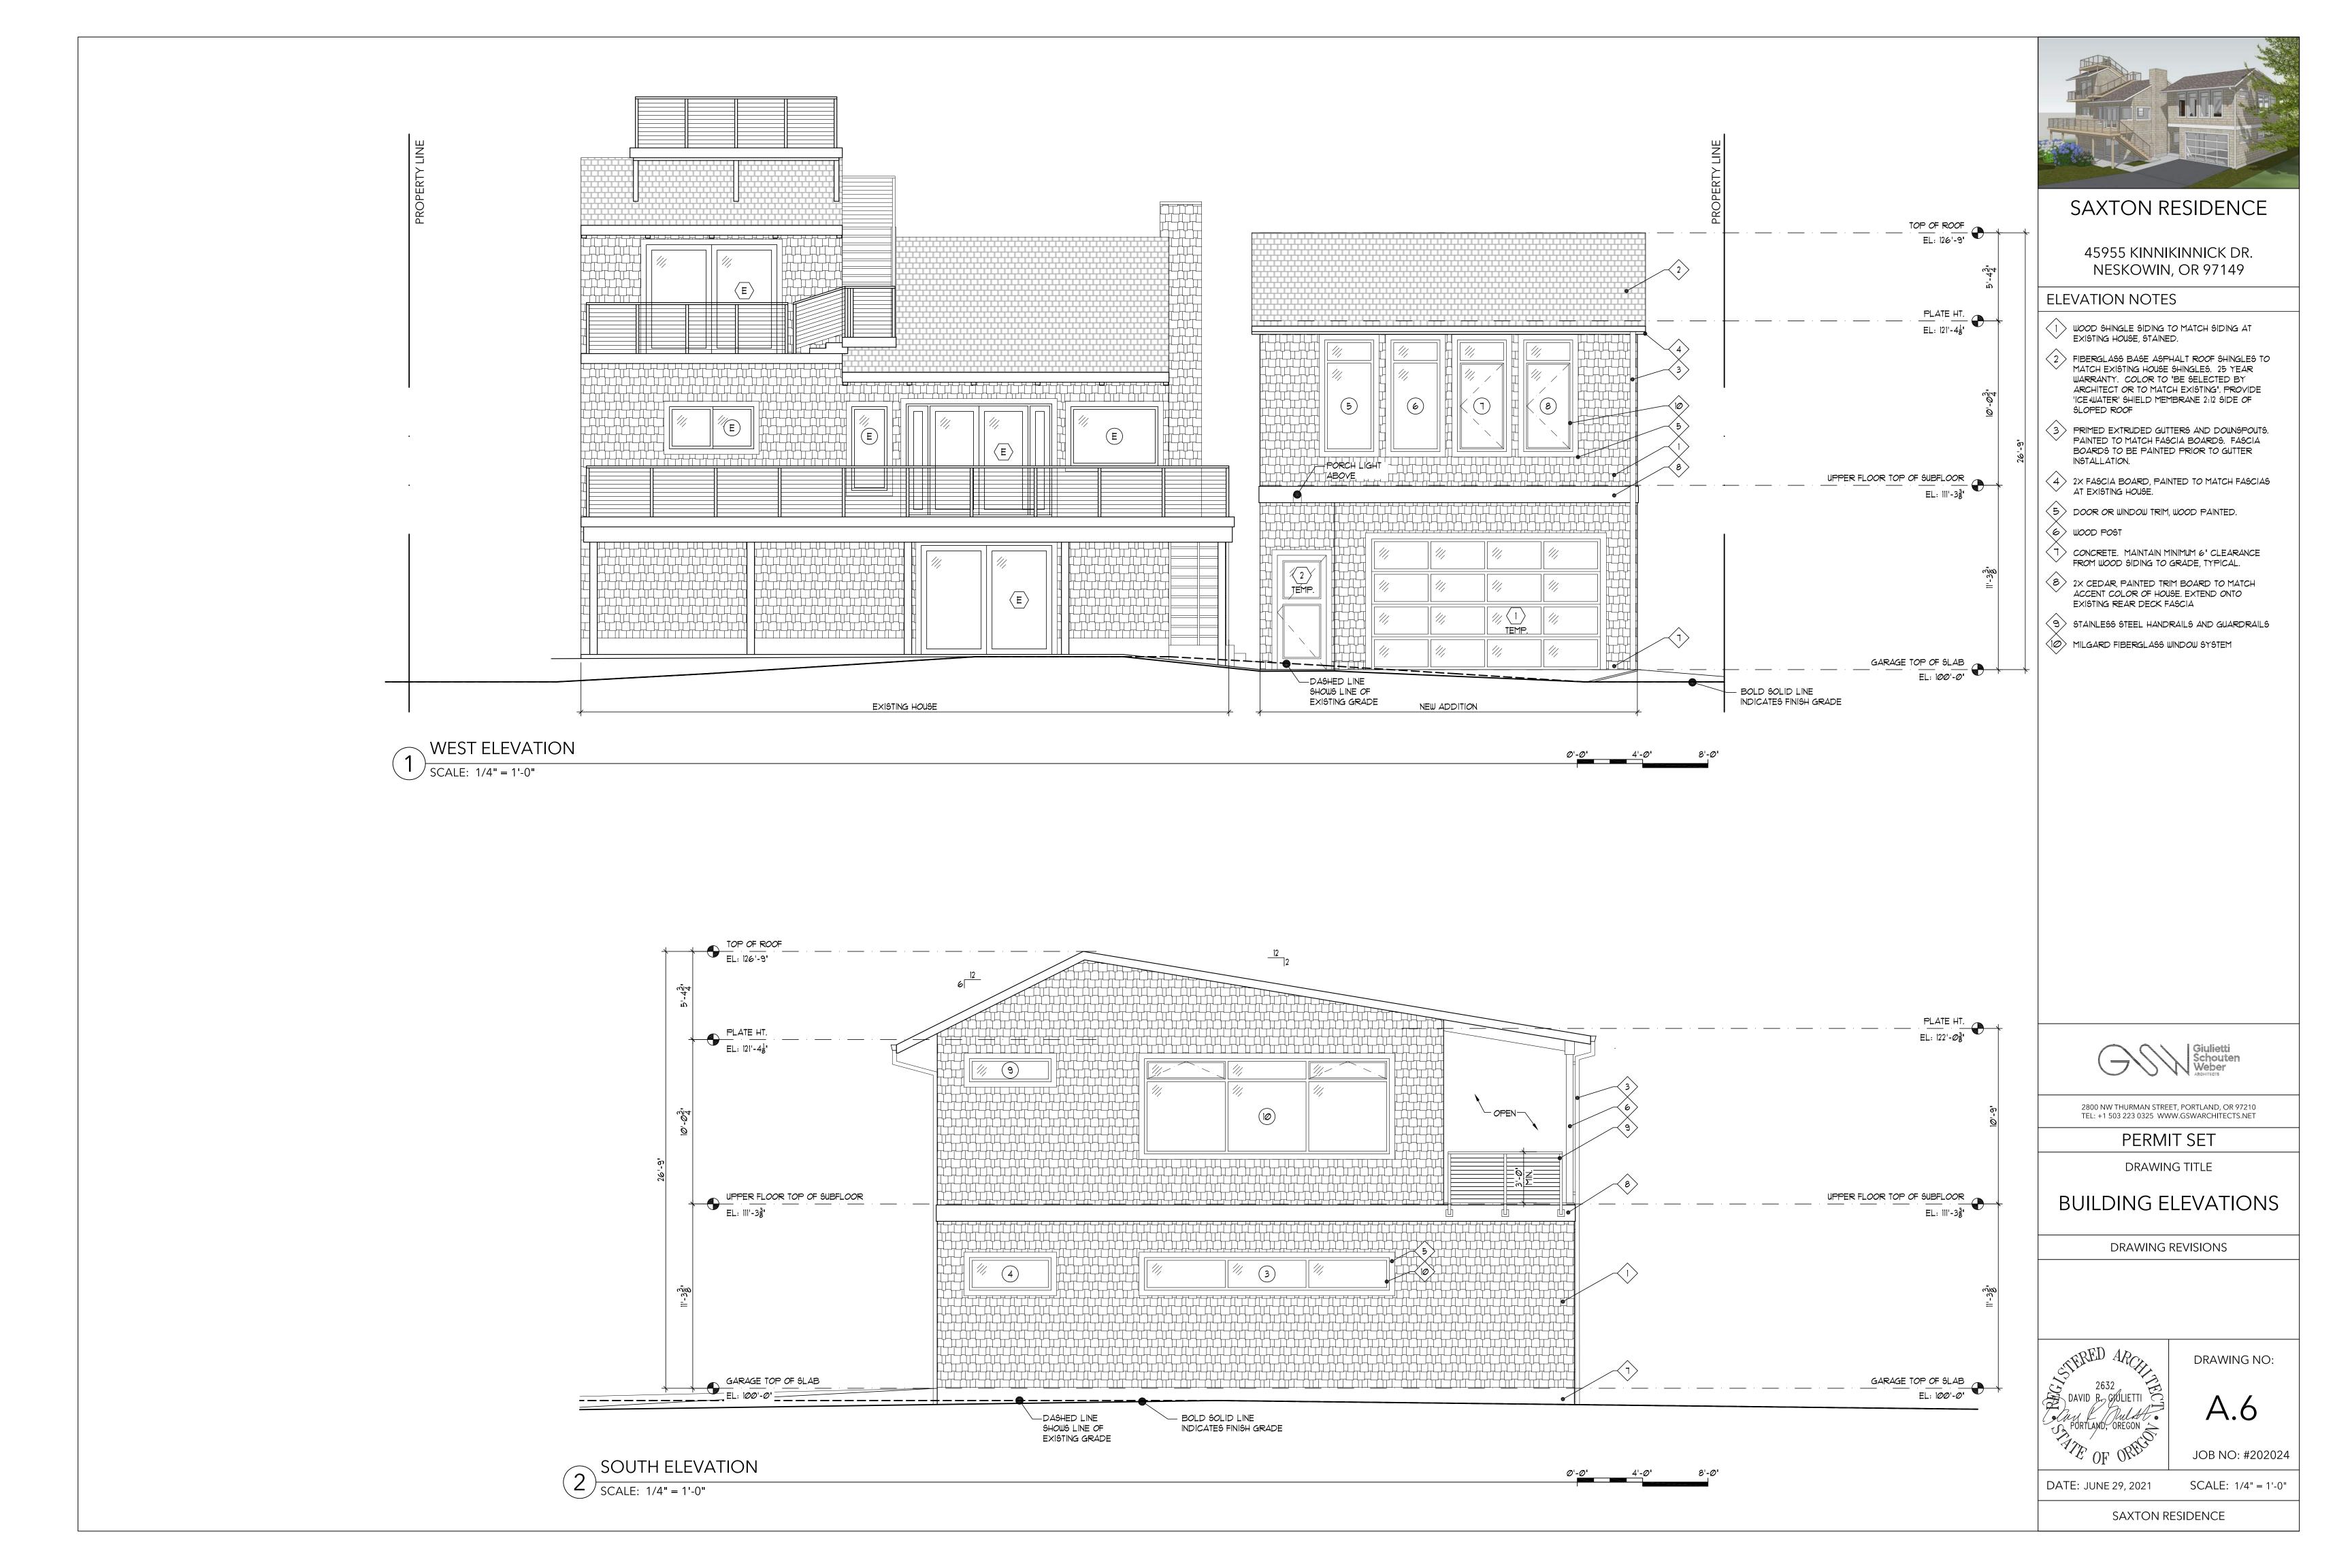
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### BUILDING ELEVATIONS

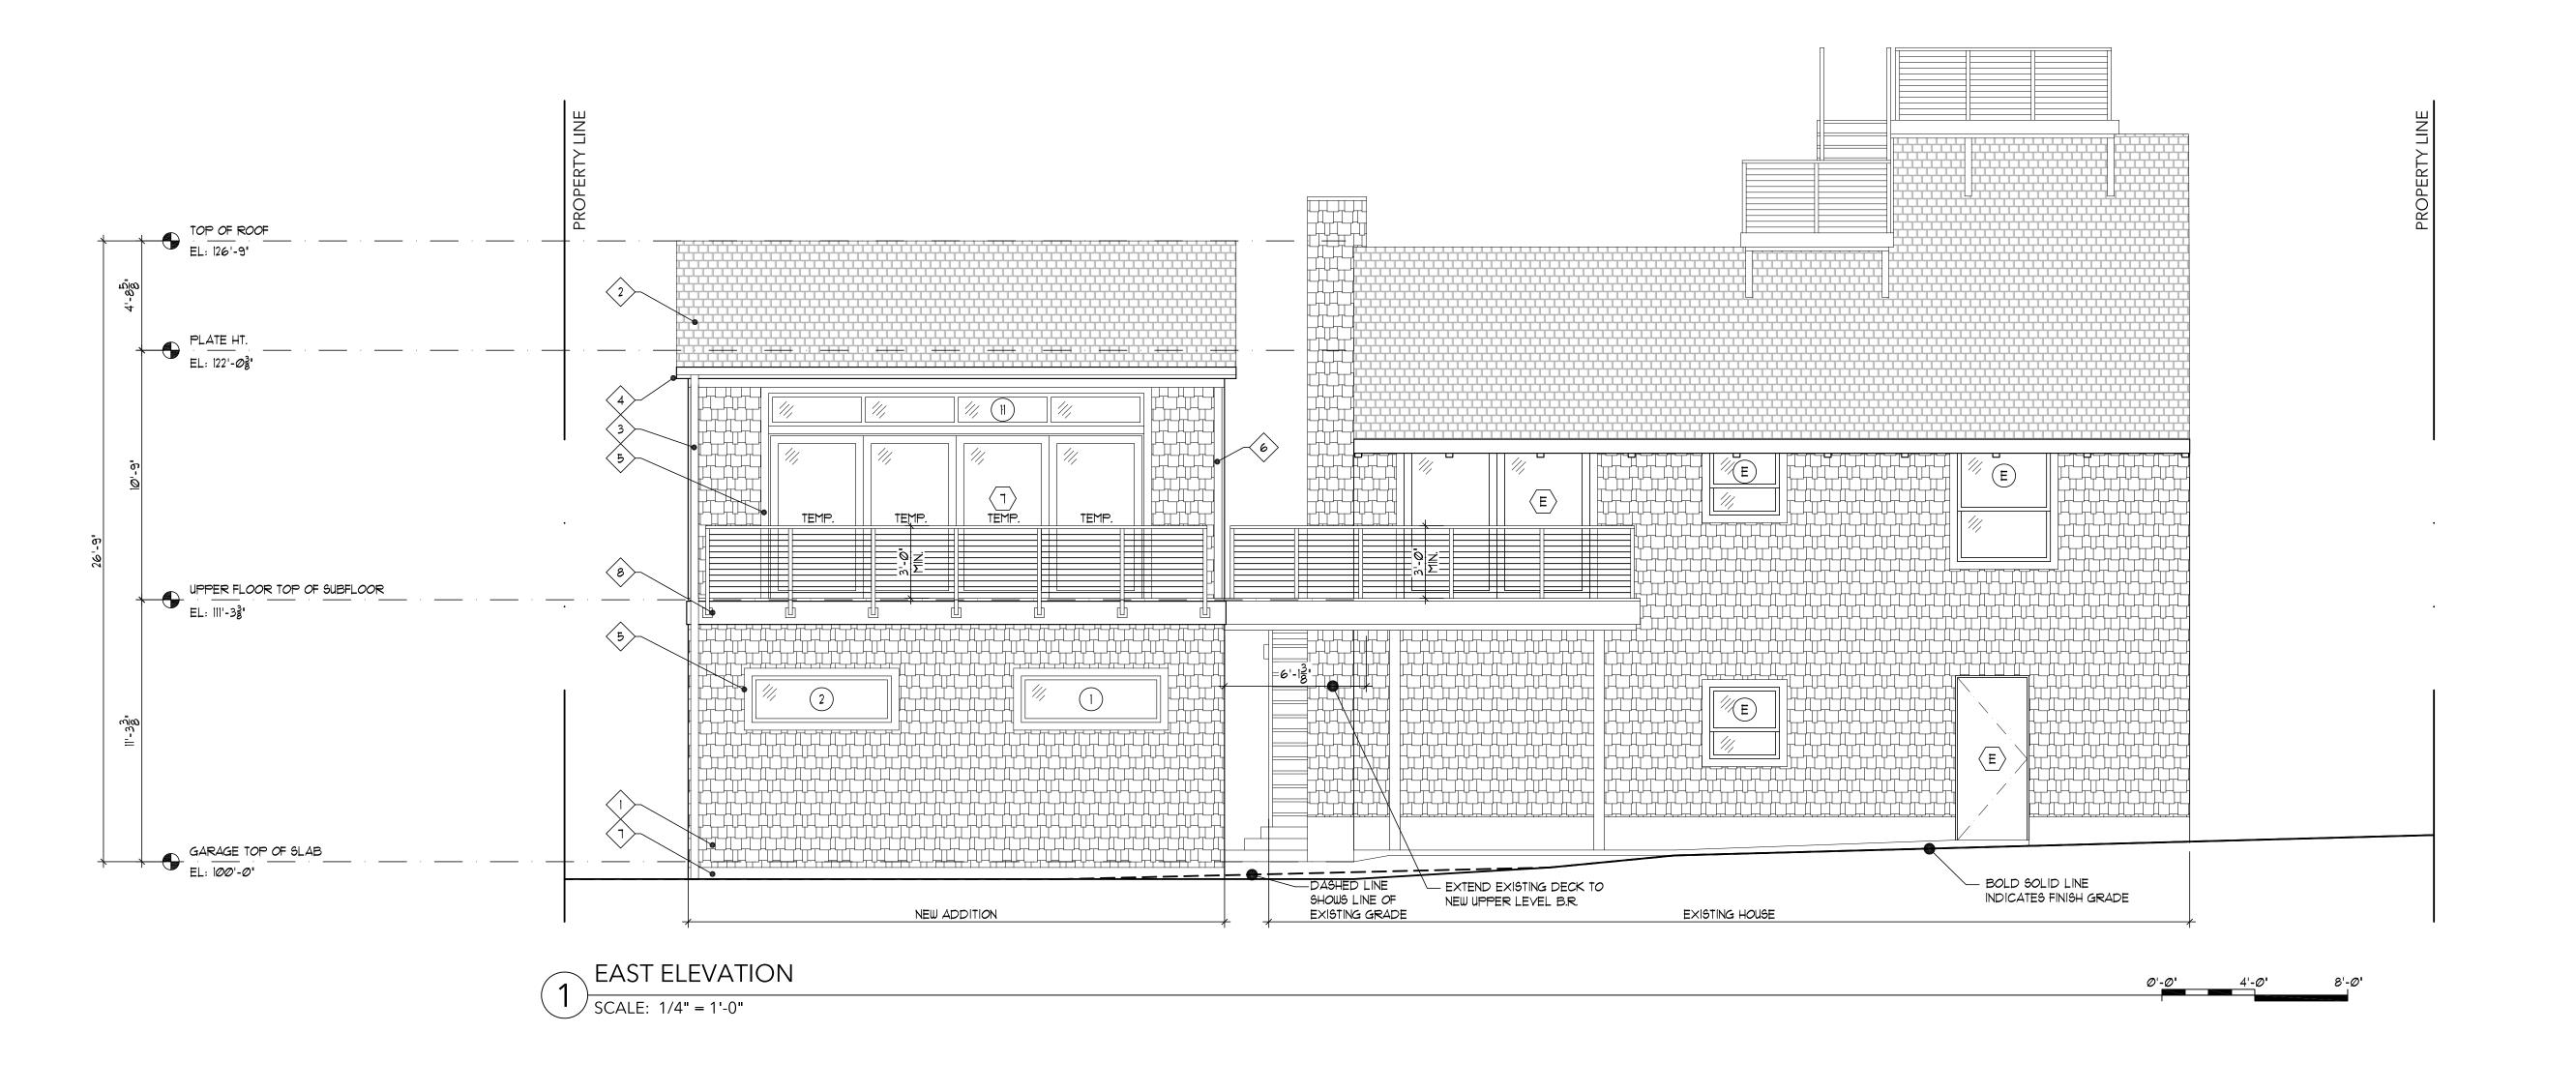DRAWING REVISIONS



DRAWING NO:

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